# **DEVELOPMENT APPLICATION SUBMISSION**

# **NEW SINGLE DWELLING 2 STOREY HOUSE**

33 Russell Street GREENACRE NSW 2190 Australia

# **DRAWING LIST**

DRAWING No	DRAWING TITLE	SCALE	SIZE
DA 00	COVER SHEET	NTS	A3
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DA 11	SITE ANALYSIS	1:200	Α3
DA 12	DEMOLITION AND SEDIMENT CONTROL PLAN	1:200	Α3
DA 13	SITE PLAN	1:200	Α3
DA 20	GROUND FLOOR	1:100	Α3
DA 21	FISRT FLOOR	1:100	Α3
DA 22	ROOF	1:100	Α3
DA 23	BASEMENT	1:100	A3
DA 24	CONCEPT LANDSCAPE	1:200	Α3
DA 30	WEST ELEVATION + AA SECTION	1:100	A2
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DA 33	FF RAMP SECTION	1:50	A2
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DA 50	SHADOW DIAGRAMS WINTER - PROPOSED	1:400	A2
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DA 52	SHADOW DIAGRAMS EQUINOX	1:100	A2
DA 53	SHADOW DIAGRAMS SUMMER	1:400	A2
DA 60	WINDOWS AND DOORS SCHEDULE	NTS	Α3
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### **APPENDIX**

STORM WATER PLAN BASIX CERTIFICATE WASTE MANAGEMENT PLAN **GEOTECH REPORT** LANDSCAPE PLAN ARBORIST REPORT
STATEMENT OF ENVIRONMENTAL EFFECTS REPORT
COST ESTIMATE

ISSUE	DATE	DESCRIPTION	APP BY
Α	16/10/2023	ISSUE FOR APPROVAL	RM
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## **DEVELOPMENT APPLICATION**

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Mr Sam Sharawneh

1. NSW LAND SERVICES
2. SDS ENGINEERING
3. PBAPTY

NEW SINGLE DWELLING 2 STOREY HOUSE

PROJECT LOCATION
33 Russell Street GREENACRE
NSW 2190 Australia

23002

**COVER SHEET** 


DRAWING NUMBER

**DA 00** 

DRAWING STATUS **NOT FOR CONSTRUCTION** 

ISSUE

Α

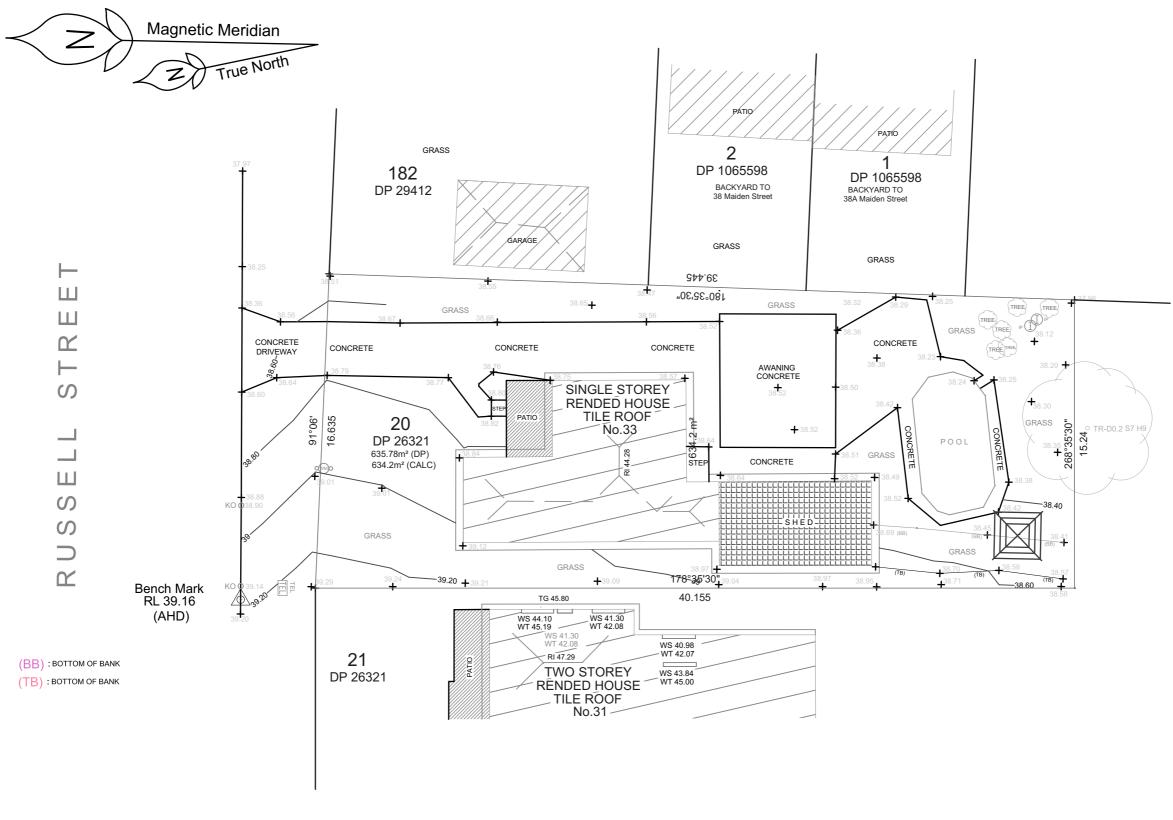





CLIENT: ALI CHOWDHURY CLIENT REF: -

SUBURB: GREENACRE

ADDRESS: 33 RUSSELL STREET

OUR PROJECT REFERENCE & DETAILS: JOB NO: 9719 L.G.A.: CANTERBURY-BANKSTOWN LOT: 20 DATUM: Australlan Helight Datum SOURCE: SCIMS

DATUM ORIGIN: SSM 141341 REDUCED LEVEL: 35.94

H HYD HYDRANT

SV STOP VALVE

WM WATER METER

TAP TAP

SEWER MAINT.

SEWER MAINT.

IP SEWER INSPECT DATE: 07-07-2023

SCHEDULE OF SYMBOLS & ABBREVIATIONS

SCALE 1:200 SHEET SIZE: A3 PAGE SURVEYED: I.S. DATE: 07-07-2023 COMPILED: S.N. DATE: 19-07-2023 1 REVIEWED: B.T. DATE: 19-07-2023


SURVEY DETAILS:

### GENERAL & SITE SPECIFIC NOTES

This survey has been undertaken for contour and detail mapping purposes only. This survey does not require strict accuracy and is not an identification survey with respect to the Surveying and Spatial Information, Act 2002 and / or, Regulation 2017. As such no accurate investigation into property boundaries has been made. Therefore any position of features and structures are approximate only. Parcel boundary dimensions' bearings and areas have been adopted from the subject deposited plan and have not been investigated, any bearing, distance, area, setback or other dimension may be subject to change with further investigation and lodgment of a plan of survey at the Land Titles Office.

Services shown have been derived from visual evidence apparent at the time of survey. It is strongly advised to visit 'dial before you dig' prior to any excavation or construction and verify critical locations with a suitably qualified service locator to AS 5488-2013 QL-A prior to any works or critical design.

It is strongly advised to review an up to date title search and give careful consideration to all items prior to any planning and/or construction.

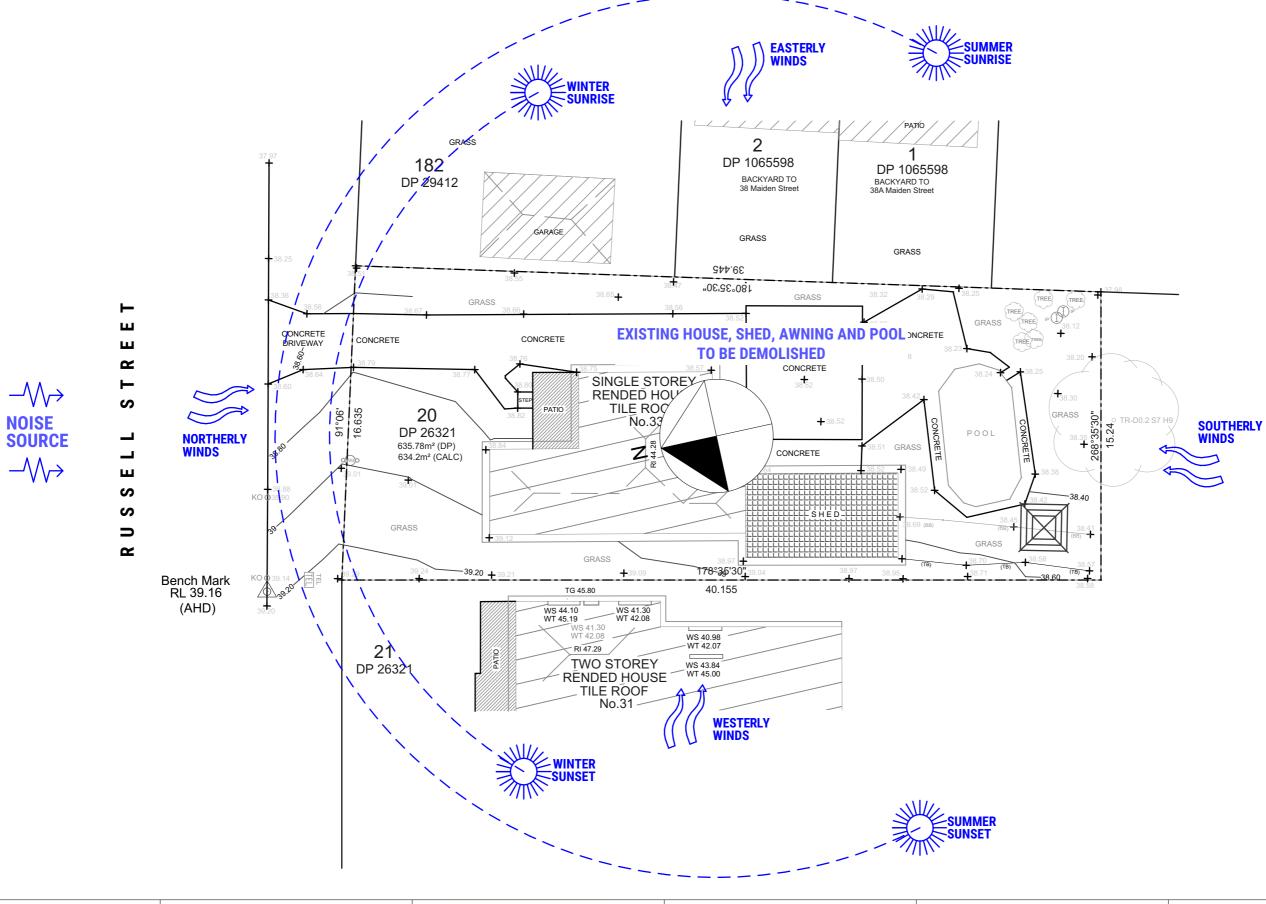

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# NEW SINGLE DWELLING 2 STOREY HOUSE

PROJECT LOCATION
33 Russell Street GREENACRE
NSW 2190 Australia
LOT 20
DP 26321

PROJECT NUMBER	
23002	

DRAWING TITLE SITE ANALY
DA 11

YSIS SCALE

ISSUE 1:200 Α DRAWING STATUS


**NOT FOR CONSTRUCTION A3** 

### **Arborist Recommendations**

I. Following assessment , the Arborist recommends the removal of T2, and T3 and T5 if

landscape renewal is proposed.

- II. For Trees 1, 4, 6 and 7 to remain viable, the following must be implemented;
- a. The concrete retainer holding T1 must remain in situ.
- b. The demolition of the existing crossover and driveway must be done so, by hand, and under the supervision of the Project Arborist
- c. The new driveway and crossover should be at existing ground levels.
- d. The bulk soil cut along the southern boundary must not occur, at minimum in the SRZ's of both T6 and T7, meaning that there will be a differentiation in soil levels at this point. Refer to Tree Protection Plan on Page 14.
- e. Where the soil cuts are approved within the TPZ of trees it is anticipated underlying tree roots will be cut. Such roots, greater than 25mm, must be blocked, by use of clean cut, sterilised tools , that will ensure rapid compartmentalisation (forming walls that protect the wound area from decay) denying the entry of fungal pathogens. Ground soil/root treatment within the TPZ is crucial in this vicinity.
- f. All trees are to be protected in accordance with AS4970:2009.

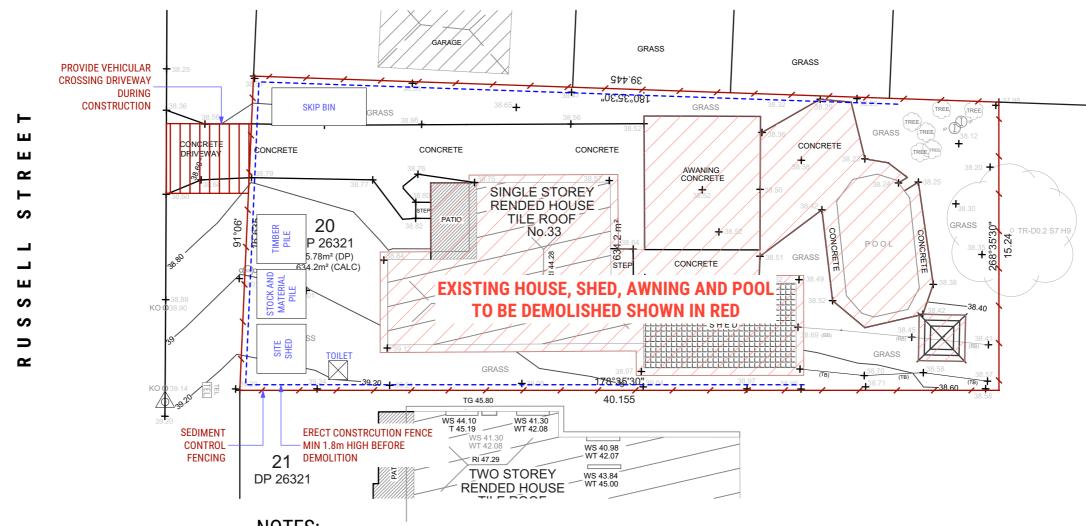

# **EROSION NOTES**

- 01. ALL EROSION AND SEDIMENT CONTROL MEASURES TO BE INSPECTED AND MAINTAINED DAILY BY SITE MANAGER.
- MINIMISE DISTURBED AREAS
- 03. ALL STOCKPILES TO BE CLEAR FROM DRAINS, GUTTERS AND FOOTPATHS.
- DRAINAGE TO BE CONNECTED TO STORMWATER SYSTEM AS SOON AS POSSIBLE. 04.
- ROADS AND FOOTPATH TO BE SWEPT DAILY.
- NO MATERIAL TO BE STORED ON FOOTPATH.
- SILTFENCE TO BE CONSTRUCTED AS PER DETAIL SHOWN OR BY USING AN APPROVED EQUIVALENT MEASURE. THE SILTFENCE IS TO BE CONSTRUCTED PRIOR TO ANY OTHER CONSTRUCTION ACTIVITIES. IT IS TO BE KEPT IN GOOD WORKING ORDER AT ALL TIMES. WHEN APPROXIMATELY 30% FULL OR AS DIRECTED BY COUNCIL'S REPRESENTATIVE

# NOTES:


- DEMOLITION IS TO BE CARRIED OUT IN ACCORDANCE WITH AUSTRALIAN STANDARD 2601-1991 THE DEMOLITION IS TO BE CARRIED OUT IN ACCORDANCE WITH ACCTUAL DEMOLITION OF STRUCTURES.

  DEMOLITION IS TO BE CARRIED OUT BY A QUALIFIED AND LICENCED DEMOLITION COMPANY.


  AS3.1.1 AT ALL TIMES DEMOLITION WORK SHALL BE SUPERVISED BY A COMPETENT PERSON.


  DEMOLISHED HOUSE TO BE RECYCLED AS PER WASTE MANAGEMENT PLAN.

- OBTAIN ALL NECESSARY PERMITS AND APPROVALS.
- ALL EXISTING SERVICES TO BE DISCONNECTED AND SEALED BEFORE DEMOLITION.
- REMOVAL OF HAZARDOUS SUBSTANCES SHALL BE CARRIED OUT BY A CONPETENT AND QUALIFIED PERSON.
- REMOVAL OF ASBESTOS SHALL BE IN ACCORDANCE WITH THE NOHSC (WORK SAFE AUSTRALIA). STRUCTURES SHALL BE DEMOLISHED PROGRESSIVELY, STOREY BY STOREY (SEQUENTIAL METHOD)
- DEMOLISHED MATERIALS SHALL BE REMOVED PROGRESSIVELY AND NOT BE ALLOWED TO ACCUMLATE ON
- DEMOLISHED MATERIALS SHALL NOT BE ALLOWED TO FALL FREELY. AS3.1.8 THE SITE SHALL BE SECURED AT ALL TIMES AGAINST THE UNAUTHORIZED ENTRY OF PERSONS OR

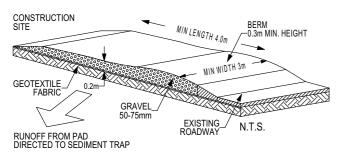

TEMPORARY CONSTRUCTION EXIT / ENTRANCE

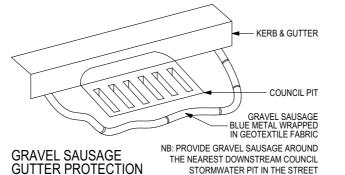

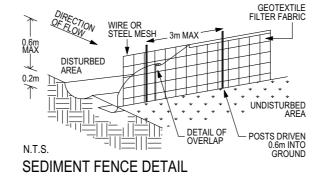

	WASTE MANAGEMENT PLAN						
Destination of Materials during Construction Stage							
On - Site Materials Re - Use & Recycling Disposal							
Material	Estimated volume	Re-use & Recycling On-Site	Recycling Off-Site	Disposal Off-Site			
Excavation	480 m³	N/A	N/A	N/A			
Green Waste	NIL	N/A	N/A	N/A			
Bricks 10 m <sup>3</sup>		separate adjacent to geotextile waste bin	'Brandown' - Kemps Creek 'Eco Cycle Materials' - Wetherill Pa 'Benedicts' - Chipping Norton				
Concrete	8 m³	on - site as all weather access	N/A	N/A			
Timber	10 m³	stored separately in geotextile waste bin	'Brandown' - Kemps Creek 'Eco Cycle Materials' - Wetherill Pa 'Benedicts' - Chipping Norton				
Plaster board and fibro	10 m³	stored seperately	recycled by 'CSR'	'CSR'			
Metals	2 m³	stored separately in geotextile waste bin	'Smorgon Steel'	'Smorgon Steel'			
Other(eg. Tiles paints, plastics, PVC tubing, cardboard)	1.0 m <sup>3</sup>	stored separately in geotextile waste bin	'Brandown' - Kemp 'Eco Cycle Material 'Benedicts' - Chippi	s' - Wetherill Park			

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**NEW SINGLE DWELLING 2 STOREY HOUSE** 

33 Russell Street GREENACRE NSW 2190 Australia

PROJECT NUMBER 23002

**DEMOLITION AND SEDIMENT** 

DRAWING NUMBER DA 12

CONTROL PLAN ISSUE

1:200

DRAWING STATUS

**NOT FOR CONSTRUCTION** 

Α

### **CALCULATIONS: SITE AREA = 632.3m<sup>2</sup>**

GROUND FLOOR = 172.97m<sup>2</sup> FIRST FLOOR = 143.16m<sup>2</sup>  $VOID = 16.10m^2$ MASTER BED FRONT BALCONY = 12.19m<sup>2</sup> BEDROOM 2 BALCONY = 4.43m<sup>2</sup>  $ALFRESCO = 53.58m^2$  $POOL = 42.91 m^2$ **TOTAL FLOOR AREA**:  $172.97m^2 + 143.16m^2 = 316.13m^2$ 

MAX 316.15m<sup>2</sup>

### **NOTES**

GROSS FLOOR AREA EXCLUDES BALCONIES, ALFRESCO, STAIRWELL (FIRST FLOOR) AND VOIDS, AREA MEASURED FROM INSIDE SKIN OF EXTERNAL WALLS.

### LANDSCAPE AREAS

 $BACKYARD = 64.36m^2$ FRONTYARD TOTAL= 150.82m<sup>2</sup> FRONTYARD LANDSCAPED = 99.38m<sup>2</sup> OR 65.8% OVERALL LANDSCAPED AREA =163.74m<sup>2</sup> = 25.42% POS: DECK + BACKYARD = 80.51m<sup>2</sup>

### **BASIX NOTES** ALTERNATIVE WATER **RAINWATER TANK**

The applicant must install a rainwater tank of at least 5000 litres on the site. This rainwater tank must meet, and be installed in accordance with, the requirements of all applicable regulatory authorities.

The swimming pool must not have a volume greater than 69 kilolitres.

The swimming pool must be outdoors.

### THERMAL PERFORMANCE AND MATERIALS COMMITMENTS - SIMULATION METHOD

-The applicant must show on the plans accompanying the development application for the proposed development, all matters which the Assessor Certificate requires to be shown on those plans. Those plans must bear a stamp of endorsement from the Accredited Assessor to certify that this is the case. The applicant must show on the plans accompanying the application for a construction certificate (or complying development certificate, if applicable), all thermal performance specifications set out in the Assessor Certificate, and all aspects of the proposed development which were used to calculate those specifications.

-The applicant must show on the plans accompanying the development application for the proposed development, the locations of ceiling fans set out in the Assessor Certificate. The applicant must show on the plans accompanying the application for a construction certificate (or complying development certificate, if applicable), the locations of ceiling fans set out in the Assessor Certificate.

-The applicant must construct the floors and walls of the dwelling in accordance with the specifications listed in the table

Construction	Area - m²	Insulation
floor - concrete slab on ground.	117	none
floor - suspended floor above open subfloor, concrete - suspended; frame: no frame.	23.7	foil-foam composite board
floor - above habitable rooms or mezzanine, concrete - suspended; frame: no frame	109	none
floor - suspended floor above garage, concrete - suspended; frame: no frame.	109	fibreglass batts or roll
garage floor - concrete slab on ground.	91.8	none
external wall: cavity brick; frame: no frame.	all external walls	foil-foam composite board
internal wall: single skin masonry; frame: no frame.	176.6	none
ceiling and roof - flat ceiling / flat roof, concrete - plasterboard internal, no frame.	212	ceiling: fibreglass batts or roll; roof: none.

The applicant must install windows, glazed doors and skylights as described in the table below, in accordance with the specifications listed in the table.

Frames	Maximum area - m2
aluminium	158.6
timber	0
uPVC	0
steel	0
composite	0

Glazing	Maximum area - m2
single	115.3
double	43.3
triple	0

### **ENERGY COMMITMENTS**

The applicant must install the following hot water system in the development, or a system with a higher energy rating: gas instantaneous with a performance of 6 stars.

### **NATURAL LIGHTIING**

The applicant must install a window and/or skylight in the kitchen of the dwelling for natural lighting.

The applicant must install a window and/or skylight in 4 bathroom (s)/toilet(s) in the development for natural lighting.

### **ALTERNATIVE ENERGY**

The applicant must install a photovoltaic system as part of the development. The applicant must connect this system to the development's electrical system.

The photovolatic system must consist of

• photovolatic collectors with the capacity to generate at least 3 peak kilowatts of electricity, installed at an angle between 25 degrees and 35 degrees to the horizontal facing west

ATE	DESCRIPTIO	ON.	APP BY	DEVELOPMENT ADDITION		CLIENT		PRO II	ECT DESCRIPTION
				9,206 RÉNDE	STOREY WS 43.84 ED HOUSE WT 45.00 E ROOF		13,940 REAR SETBACK		<del>.</del>
			39.20	WI 45.19 WS 41.30 WT 42.08	17,000 <sub>WS</sub> 40.98	3,950 POOL	3,000 , 10,770 ALFRESCO	6,050	<del>.</del>
	† 006	•	NOW 39.14	8,577 TG 45.80 FRONT SETBACK WS 44.10	5 STAR GAS HOTS WATER SYSTEM	5000L RWT FOR IRRIGATION OF PLANTS AND LAUNDRY		38.58	<b>•</b>
	+	ļ	KO 0 39 14	29 39.24 39.20 430.21	+3.09 178°35°40 <u>"</u> 39.04	38.97 38.95	(TB) (TB)	38.57 (TB)	
		5,3	MASONRY WALL FENCE ———————————————————————————————————	GRASS +39		If AREA	FRESCO A 53.58m <sup>2</sup> 39.110	1,000	5,
R U	9,540	5,300	38.88 KO @38.90 MASONRY	FRONTYARD AREA 99.38m <sup>2</sup>		POOL BALUSTRA FENCE 1.2m HIG TO AS 1926	DE A SH- 5.1	SdWnd 100d	5,500
SSE			88°		NEW 2 STOREY HOUSE - RL 39.300				15.20
11	13,740	3,070	7	201000 (20000) (200		007.5 7.5 7.5 7.5 7.5 7.5 7.5 7.5 7.5 7.5		) (STRASS ) 5 (STRASS ) 5 (STR	15.24 ° 2.200 2.200 °
STR	+	.	38.60 FF		FF WIS		DECK RL 38.500	AREA 64.36m <sup>2</sup>	
EET	4,830	5,450	REQUIREMENTS	DRIVEWAY RAMP		SWIMMING PO POOL COPPING RL 38.730	OL	BACKYARD	2,900
	1		NEW DRIVEWAY TO COUNCIL REQUIREMENTS	PLANTER	COURTYARD COURTYARD RL 39.450	2,81		POS: 80.51m <sup>2</sup>	2,340
	2,249	†	28 36	38.55.159 CDASS 11 Wat			1056		37.98
	† †		<del>-</del> 38.25	FRONT SETBACK	HIGH PRIVACY FEATURE WALL 977-68	, 3,950 P00L GRASS	3,000 DECK	6,050	+
				9,419 GARAGE	5,190	10,9 <b>0</b> 0 POOL	.	,950	₹
				DP 29412 10,491	BACKYARD 38 Maiden St 15,930	TO BACKYARD 38A Maiden S	TO Street 13.000		
			37 <u>.</u> 97	GRASS 182	DP 106559	8 1			
					рАтю	PAJ	710		

ISSUE	DATE	DESCRIPTION	APP BY
Α	16/10/2023	ISSUE FOR APPROVAL	RM
В	08/01/2023	ISSUE FOR APPROVAL	RM

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# Mr Sam Sharawneh

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NEW SINGLE DWELLING 2 STOREY HOUSE


PROJECT LOCATION
33 Russell Street GREENACRE NSW 2190 Australia LOT 20 DP 26321


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23002

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DA 13 1:200	В	
DRAWING NUMBER SCALE	ISSUE	
DRAWING TITLE SITE PLAN		



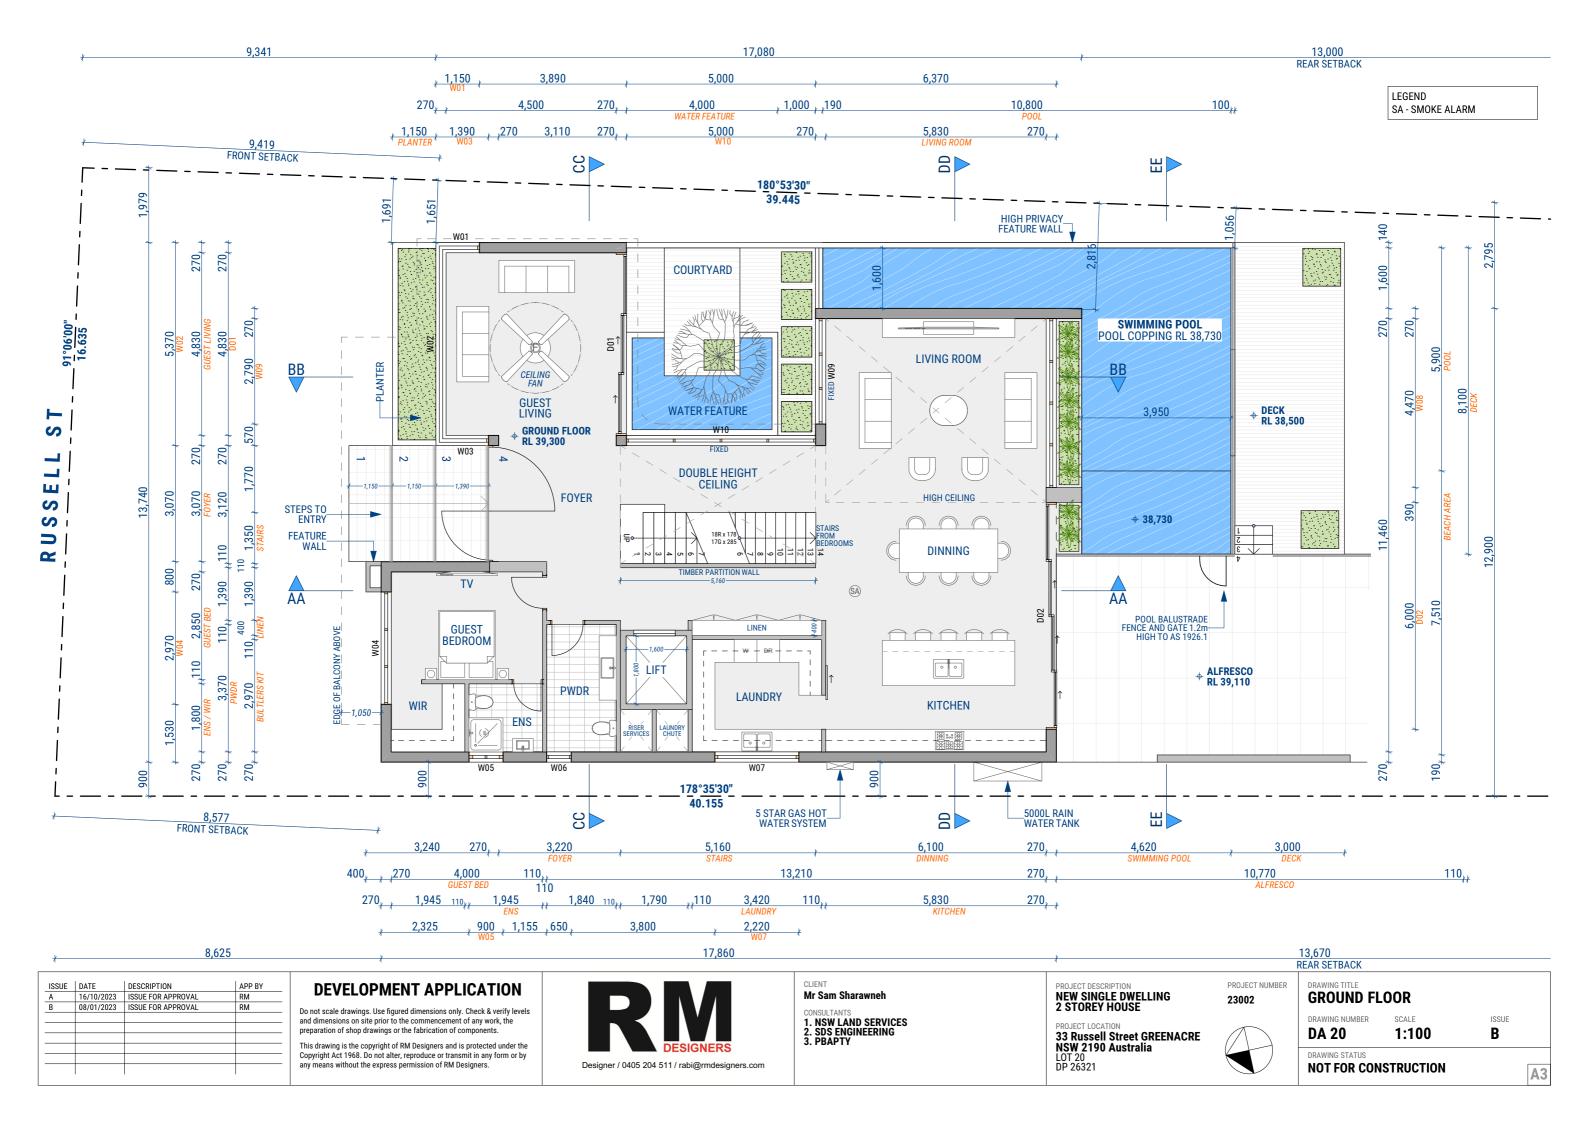

ISSUE	DATE	DESCRIPTION	APP BY
A	16/10/2023	ISSUE FOR APPROVAL	RM
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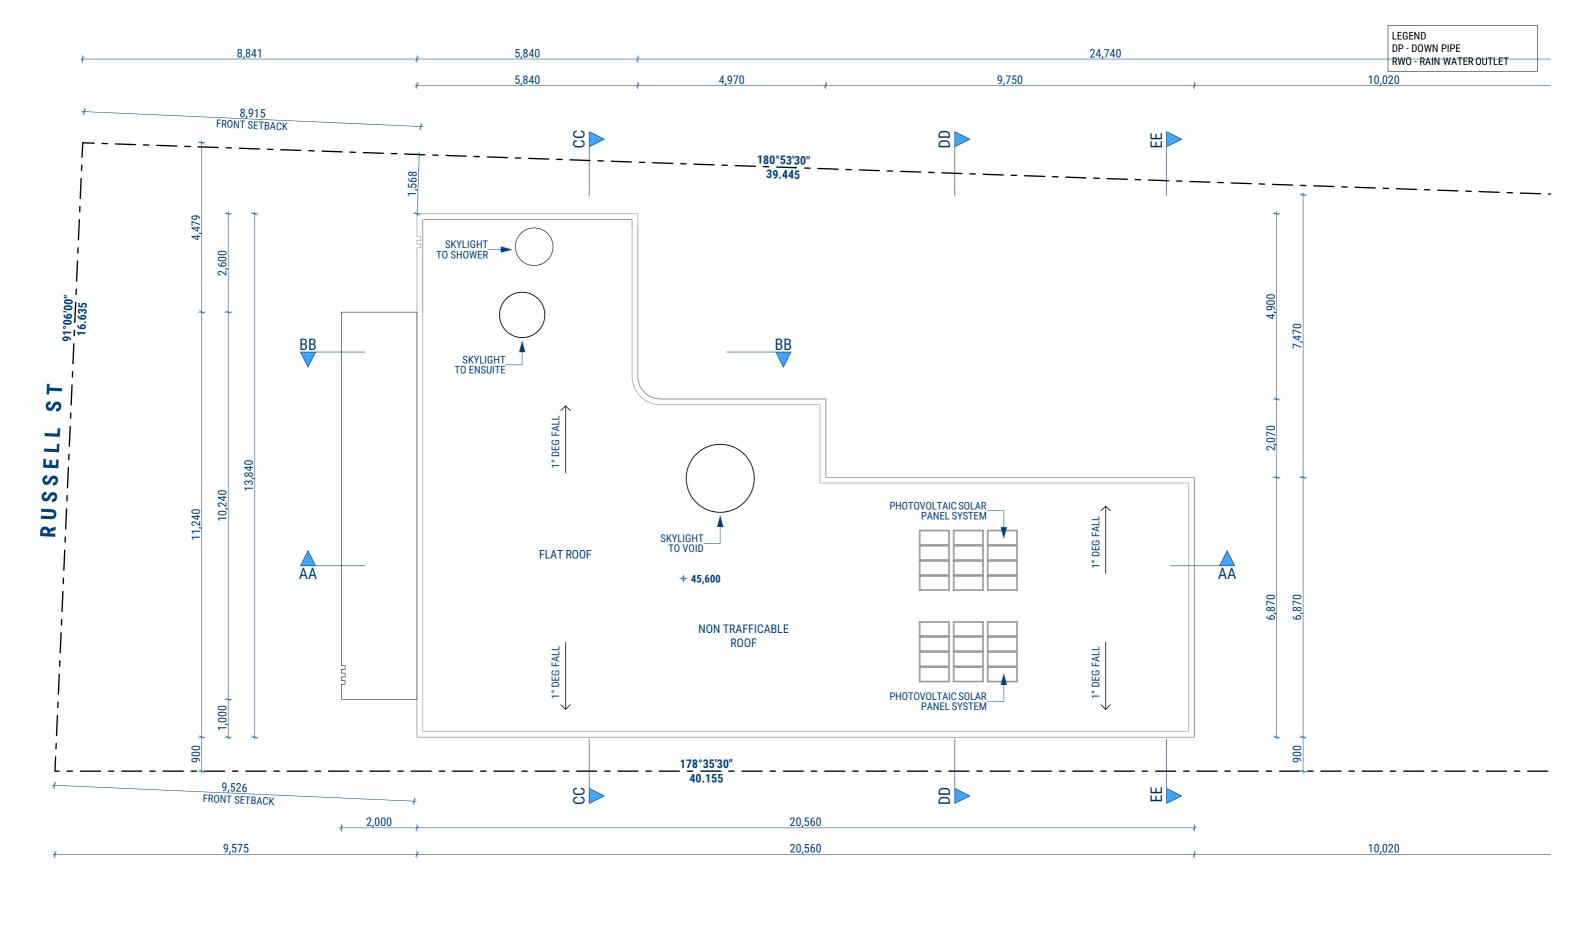
**FISRT FLOOR** 

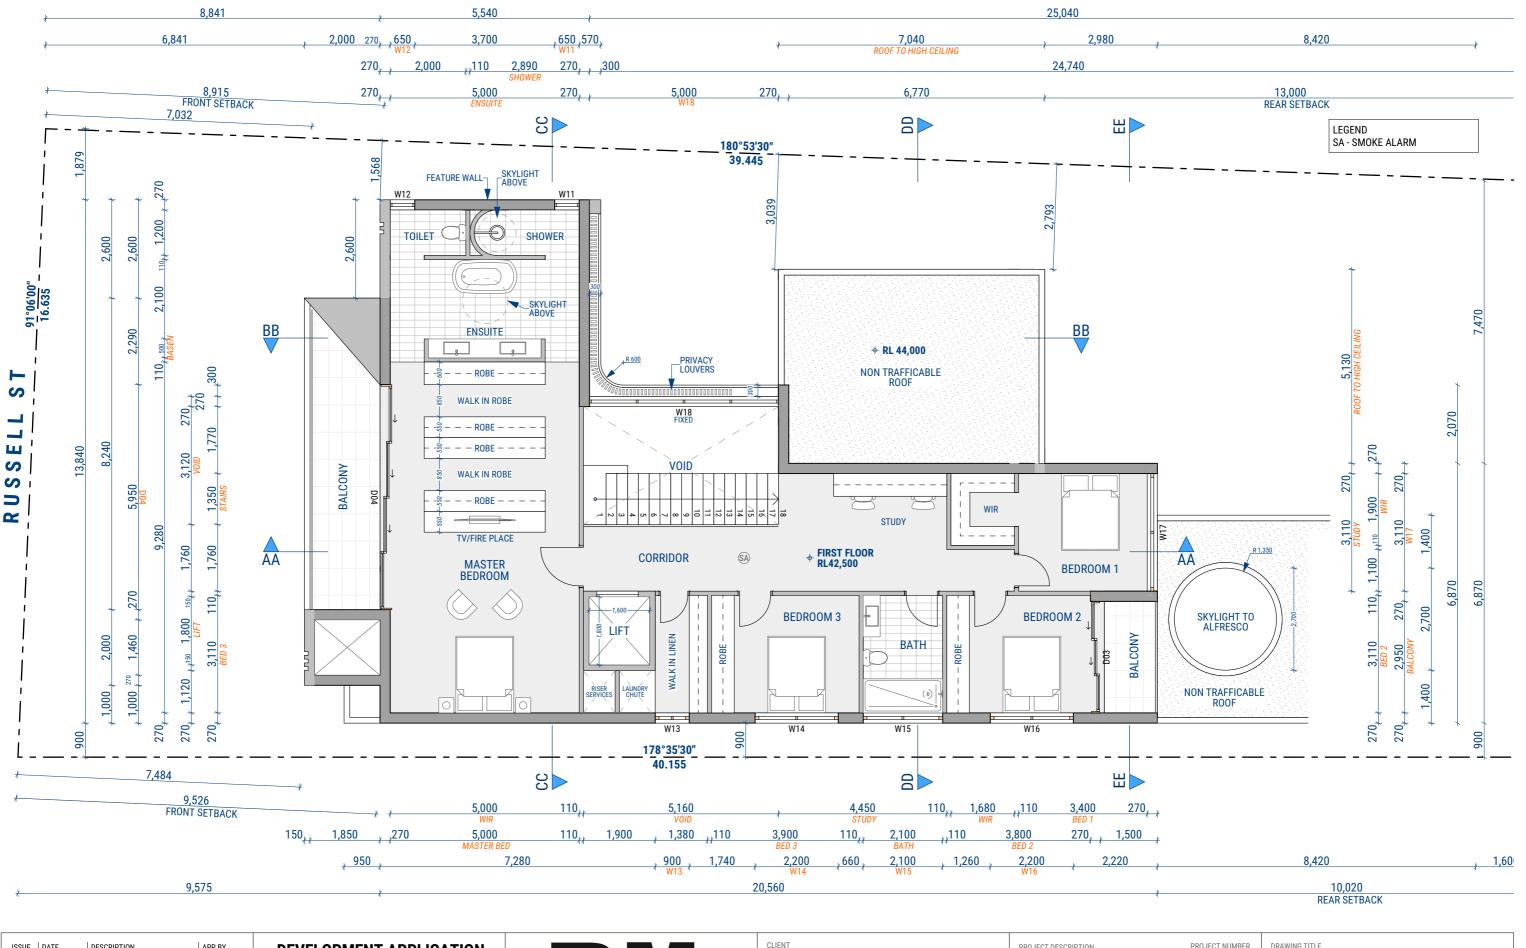DRAWING NUMBER DA 21

SCALE ISSUE 1:100 В

**A3** 

DRAWING STATUS **NOT FOR CONSTRUCTION** 



13	SSUE	DATE	DESCRIPTION	APP BY
7	4	16/10/2023	ISSUE FOR APPROVAL	RM
E	3	08/01/2023	ISSUE FOR APPROVAL	RM

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# CLIENT Mr Sam Sharawneh

CONSULTANTS 1. NSW LAND SERVICES
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2 STOREY HOUSE

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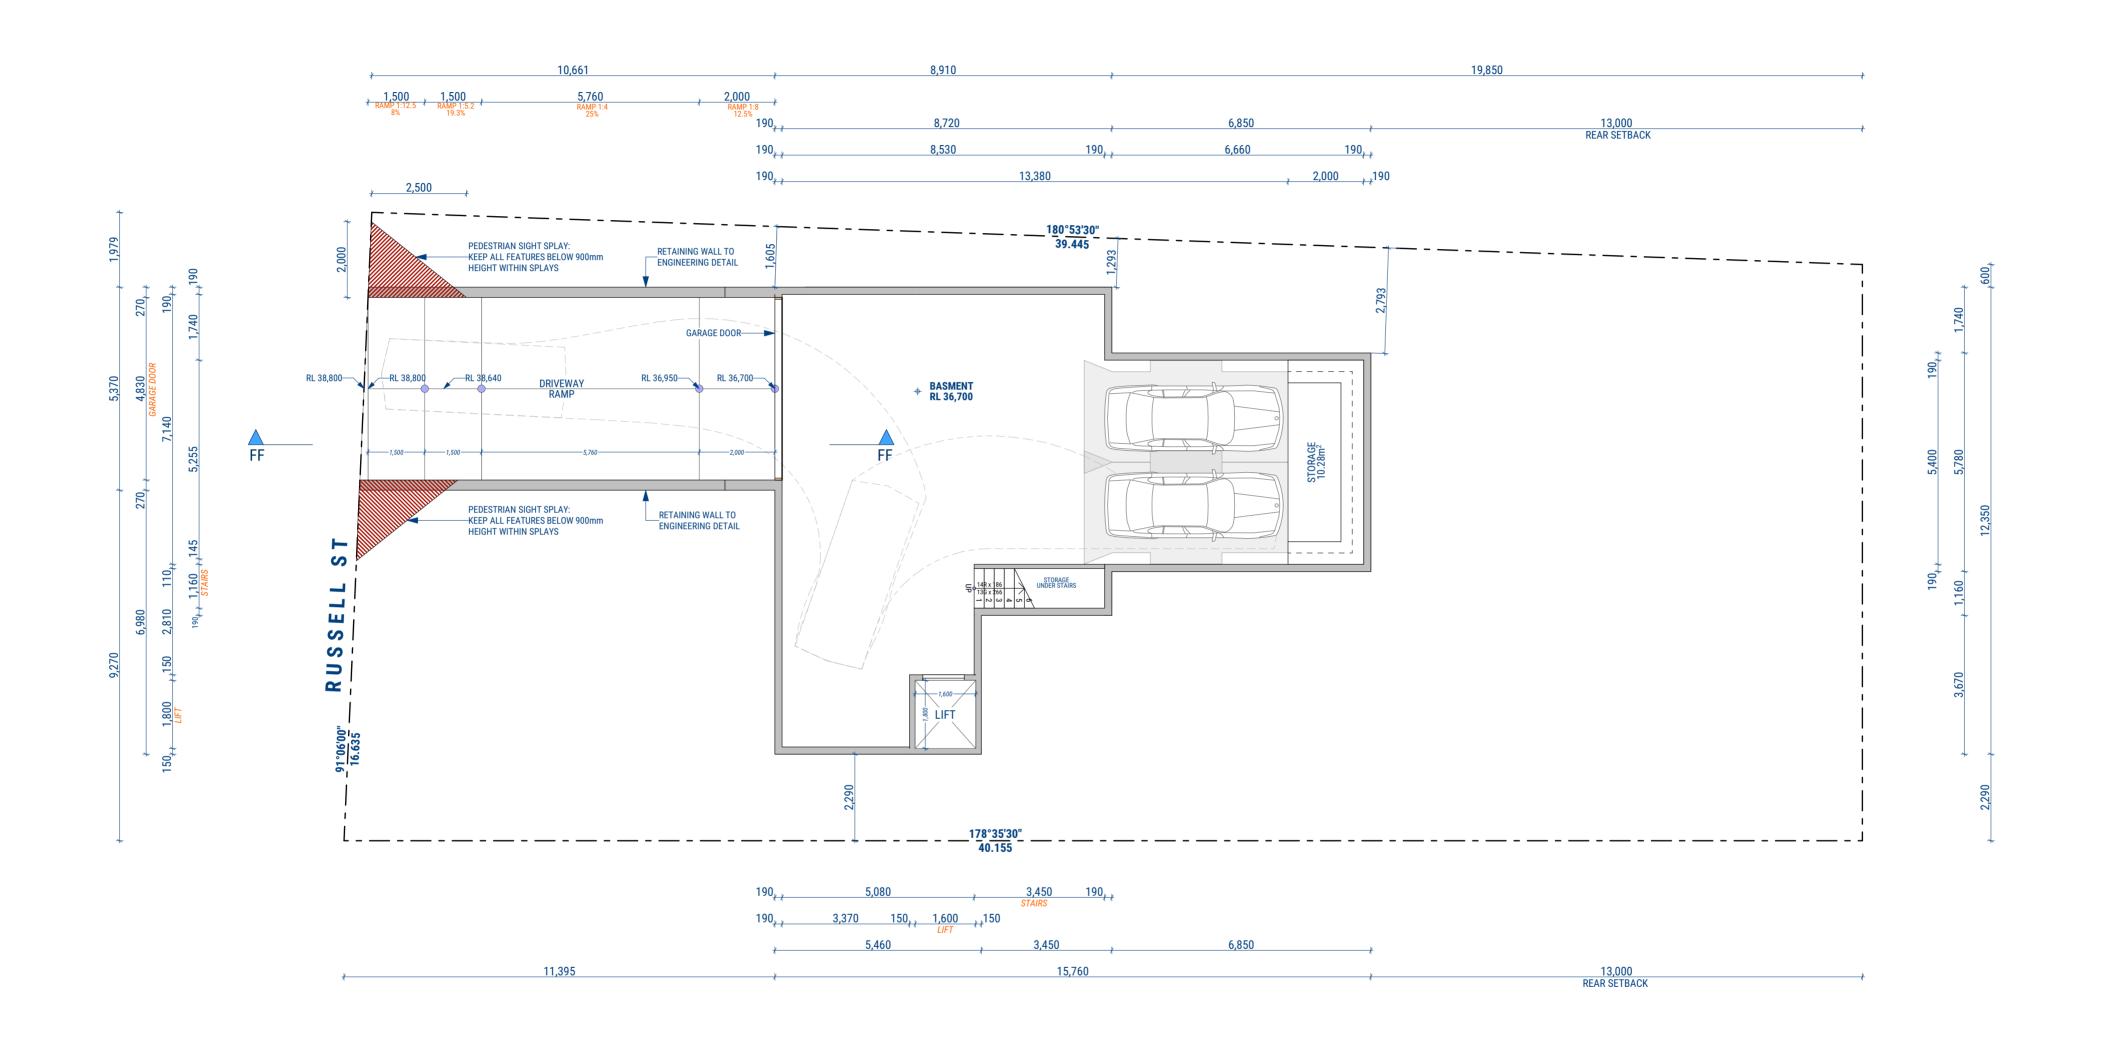
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WING NUMBER 22

SCALE ISSUE В 1:100

DRAWING STATUS **NOT FOR CONSTRUCTION A3** 



ISSUE	DATE	DESCRIPTION	APP BY	DEVELOPMENT APPLICATION
Α	16/10/2023	ISSUE FOR APPROVAL	RM	DEVELOR MICH I AFF CIGATION
В	08/01/2023	ISSUE FOR APPROVAL	RM	Do not scale drawings. Use figured dimensions only. Check & verify lev
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Mr Sam Sharawneh  CONSULTANTS
1. NSW LAND SERVICES

PROJECT DESCRIPTION NEW SINGLE DWELLING 2 STOREY HOUSE
PROJECT LOCATION 33 Russell Street GREENACRE NSW 2190 Australia LOT 20 DP 26321

	DRAWING STATUS  NOT FOR CON	OTRUCTION	
	DA 23	scale 1:100	ISSUE <b>B</b>
PROJECT NUMBER 23002	DRAWING TITLE BASEMENT		

### LANDSCAPE AREAS

### SITE AREA = 632.3m<sup>2</sup>

BACKYARD = 64.36m<sup>2</sup> FRONTYARD TOTAL= 150.82m<sup>2</sup> FRONTYARD LANDSCAPED = 99.38m<sup>2</sup> OR 65.8% OVERALL LANDSCAPED AREA =163.74m<sup>2</sup> = 25.42% POS: DECK + BACKYARD = 80.51m<sup>2</sup>





Destiny



Tenax Purpureum

Westringia fruticosa Odoratissimum



Lagerstroemia indica





EXISTING TREE PROTECTION DETAIL

Magnolia - Little Gem


PAVING OR EDGING AS DETAILED AND INDICATED ON LANDSCAPING PLAN TURF SPECIES AS INDICATED ON LANDSCAPE PLAN 100mm DEPTH TOPSOIL MIX RETILIZER CULTIVATED SUB BASE 150mr GROUND PREPARATION GRASSED AREA: TURF USING IMPORTED TOPSOIL DETAIL SHRUR PLANTING IN GARDEN BED BRICK-ON-FLA MULCH



GROUND PREPARATION PLANTING AREA USING IMPORTED TOPSOIL DETAIL

PAVING OR EDGING

CULTIVATED OR RIPPED SUB BASE

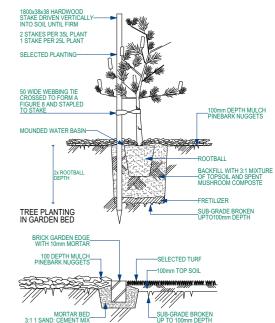

TURF & GARDEN EDGE DETAIL

PLAN

BRICK GARDEN EDGE DETAIL

## TURF

Excavate / grade all areas to be turfed to 120mm below required finished levels. Do not excavate within 1500mm of the trunk of any existing tree to be retained. Ensure that all surface water runoff is directed towards the inlet pits, kerbs etc.. and away from buildings. Ensure that no pooling or ponding will occur. Rip the subgrade to 150mm. Install 100mm depth of imported topsoil. Just prior to spreading the turf, spread "Shirley's No.17 lawn fertilizer" over the topsoil at the recommended rate. Lay "Kikuyu" turf rolls closely butted. Fill any small gaps with topsoil. Water thoroughly.

Brick Garden Edging
Lay a single coarse of paving bricks in a mortar haunch (200mm wide and 100mm deep). The edges are to be laid in even curves and straight line as shown on the plan. Where tight curves are shown use half bricks to show a more even curve. The top of the edge is to finish flush with the adjacent turf and mulch levels.


### Planting areas

Ensure that the mass planting areas have been excavated to 300 below finished levels. Rip to a further depth of 150mm. Supply and install 300mm soil mix. Soil mix to comprise of one part approved compost to three parts topsoil. Topsoil shall be either imported topsoil or stockpiled site topsoil (if suitable ie: No clay) Install 75mm depth of selected mulch.

### Note: Maintenance:

All landscape works are to be maintained for a period of three months from the date of practical completion. This includes all watering, weeding, spraying and re-mulching necessary to achieve vigorous growth. Any defects which arise during this period are to be rectified immediately. Any plants or areas of turf which fail during this period are to be replaced at no additional cost. are to be replaced at no additional cost.



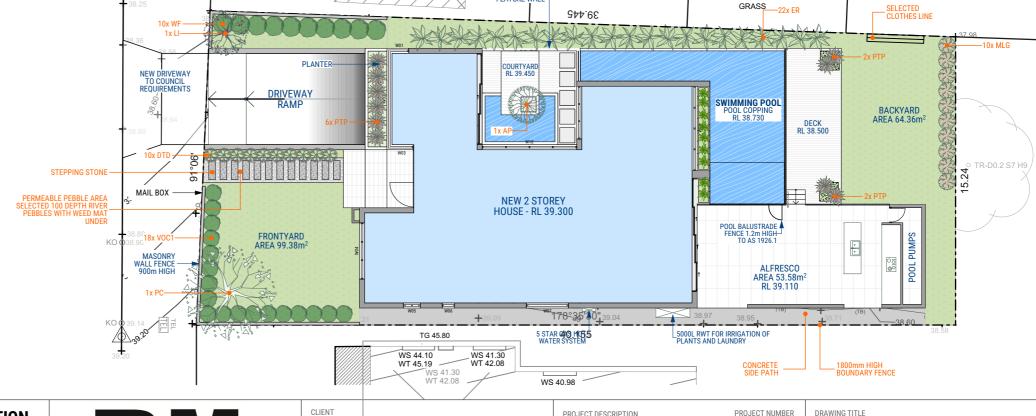

ISSUE	DATE	DESCRIPTION	APP BY
Α	16/10/2023	ISSUE FOR APPROVAL	RM
В	08/01/2023	ISSUE FOR APPROVAL	RM

### **DEVELOPMENT APPLICATION**

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Designer / 0405 204 511 / rabi@rmdesigners.com

# Mr Sam Sharawneh


1. NSW LAND SERVICES 2. SDS ENGINEERING 3. PBAPTY

**NEW SINGLE DWELLING** 2 STOREY HOUSE


33 Russell Street GREENACRE NSW 2190 Australia LOT 20 DP 26321

23002

**CONCEPT LANDSCAPE** DRAWING NUMBER ISSUE В **DA 24** 1:200 DRAWING STATUS **NOT FOR CONSTRUCTION A3** 

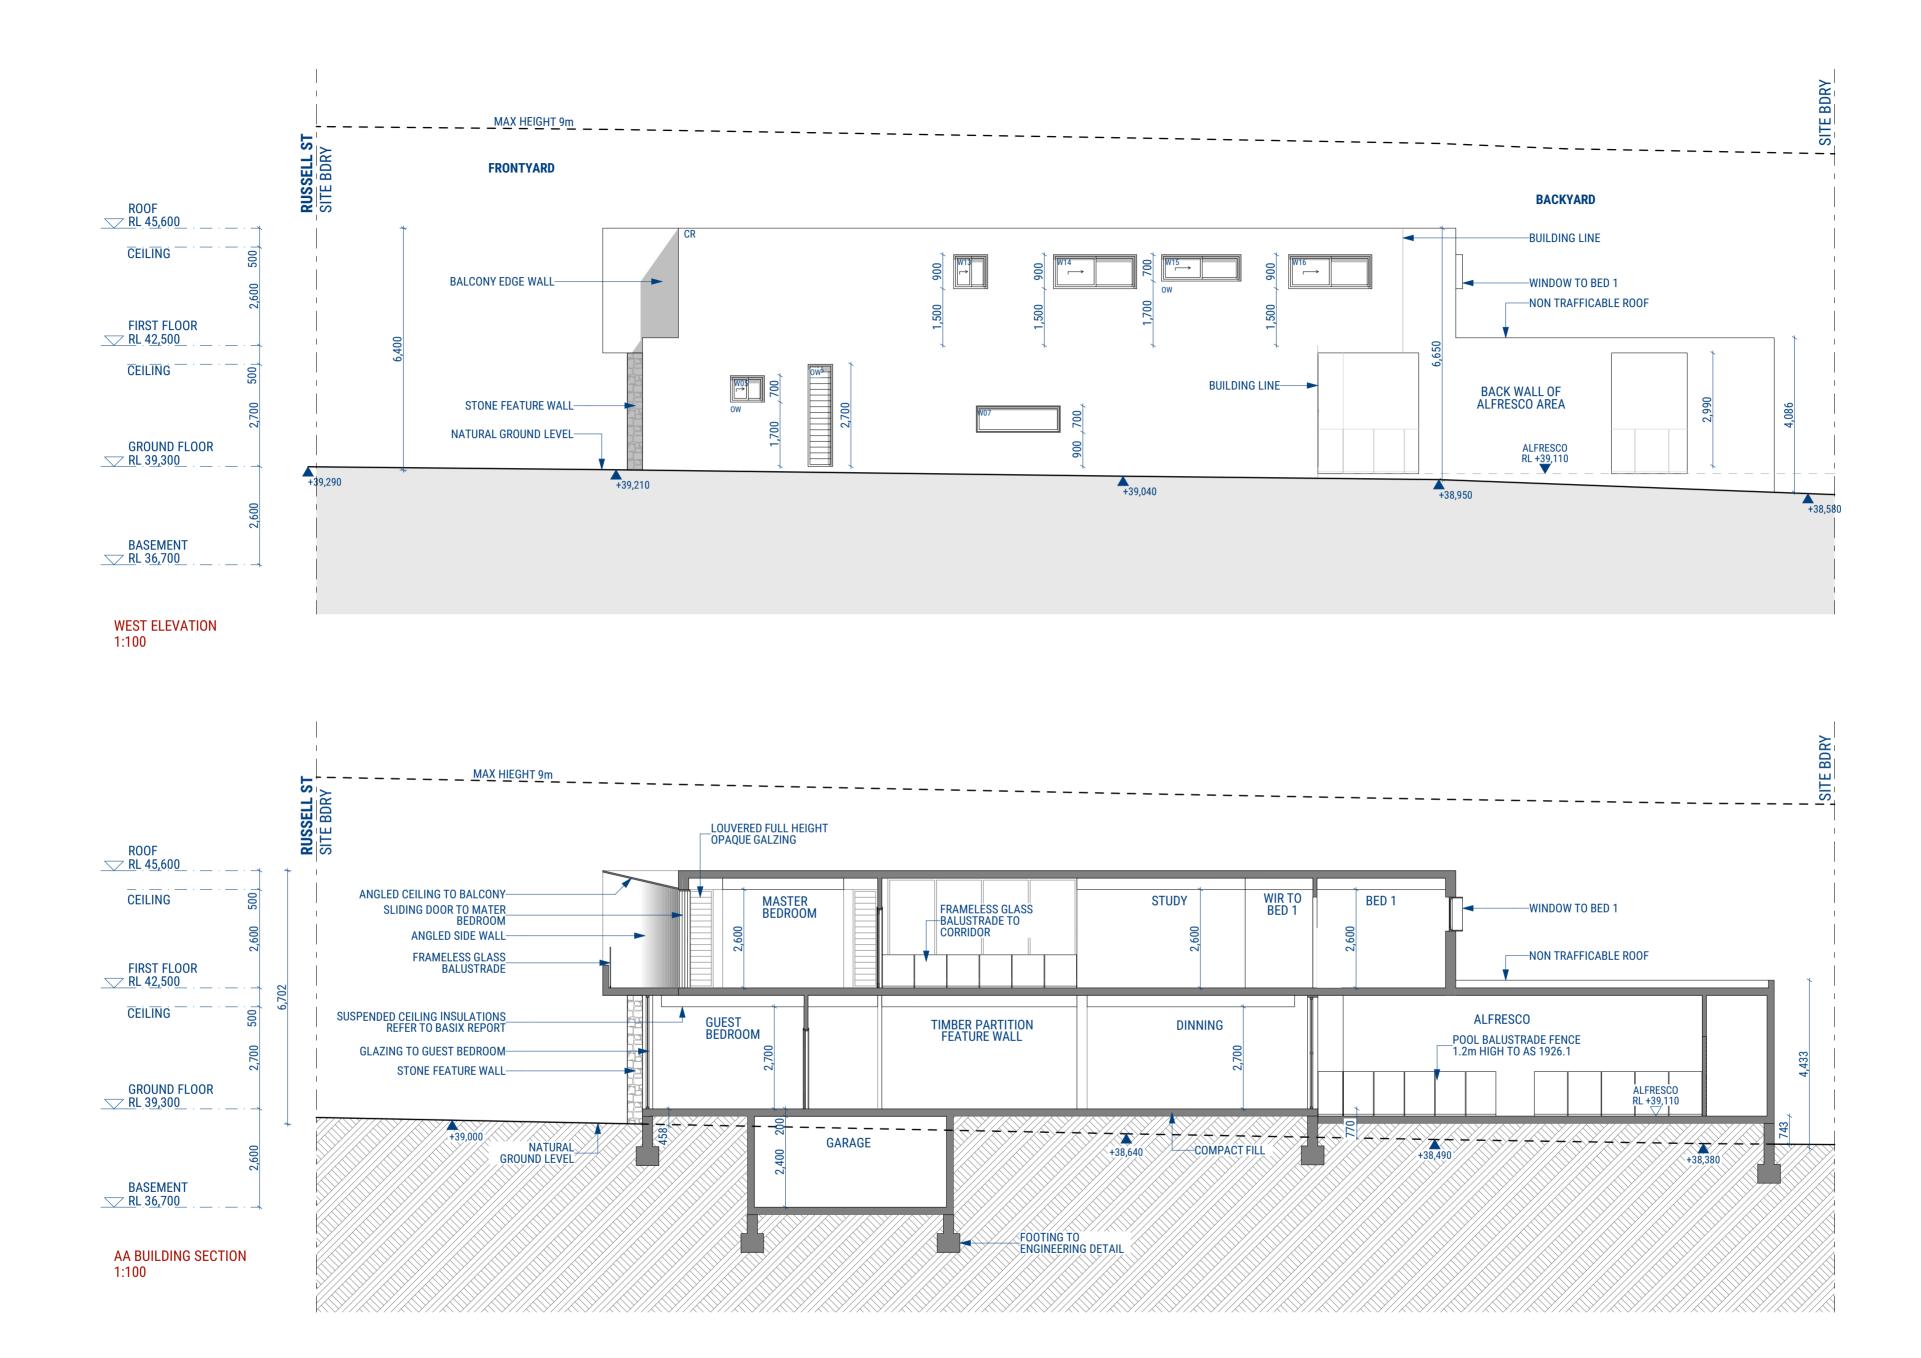

ISSUE DATE DESCRIPTION APP BY A 16/10/2023 ISSUE FOR APPROVAL RM B 08/01/2023 ISSUE FOR APPROVAL RM Do not scale drawings. Use figured dime		CLIENT Mr Sam Sharawneh	PROJECT DESCRIPTION NEW SINGLE DWELLING 2 STOREY HOUSE	PROJECT NUMBER 23002	WEST ELEVATION + AA	A SECTION
and dimensions on site prior to the com  preparation of shop drawings or the fabi  This drawing is the copyright of RM Des	nmencement of any work, the rication of components.	CONSULTANTS 1. NSW LAND SERVICES 2. SDS ENGINEERING 3. PBAPTY	PROJECT LOCATION 33 Russell Street GREENACRE NSW 2190 Australia		DA 30 SCALE 1:100	ISSUE <b>B</b>
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CLIENT
Mr Sam Sharawneh
CONSULTANTS
1. NSW LAND SERVICES
2. SDS ENGINEERING
3. PBAPTY

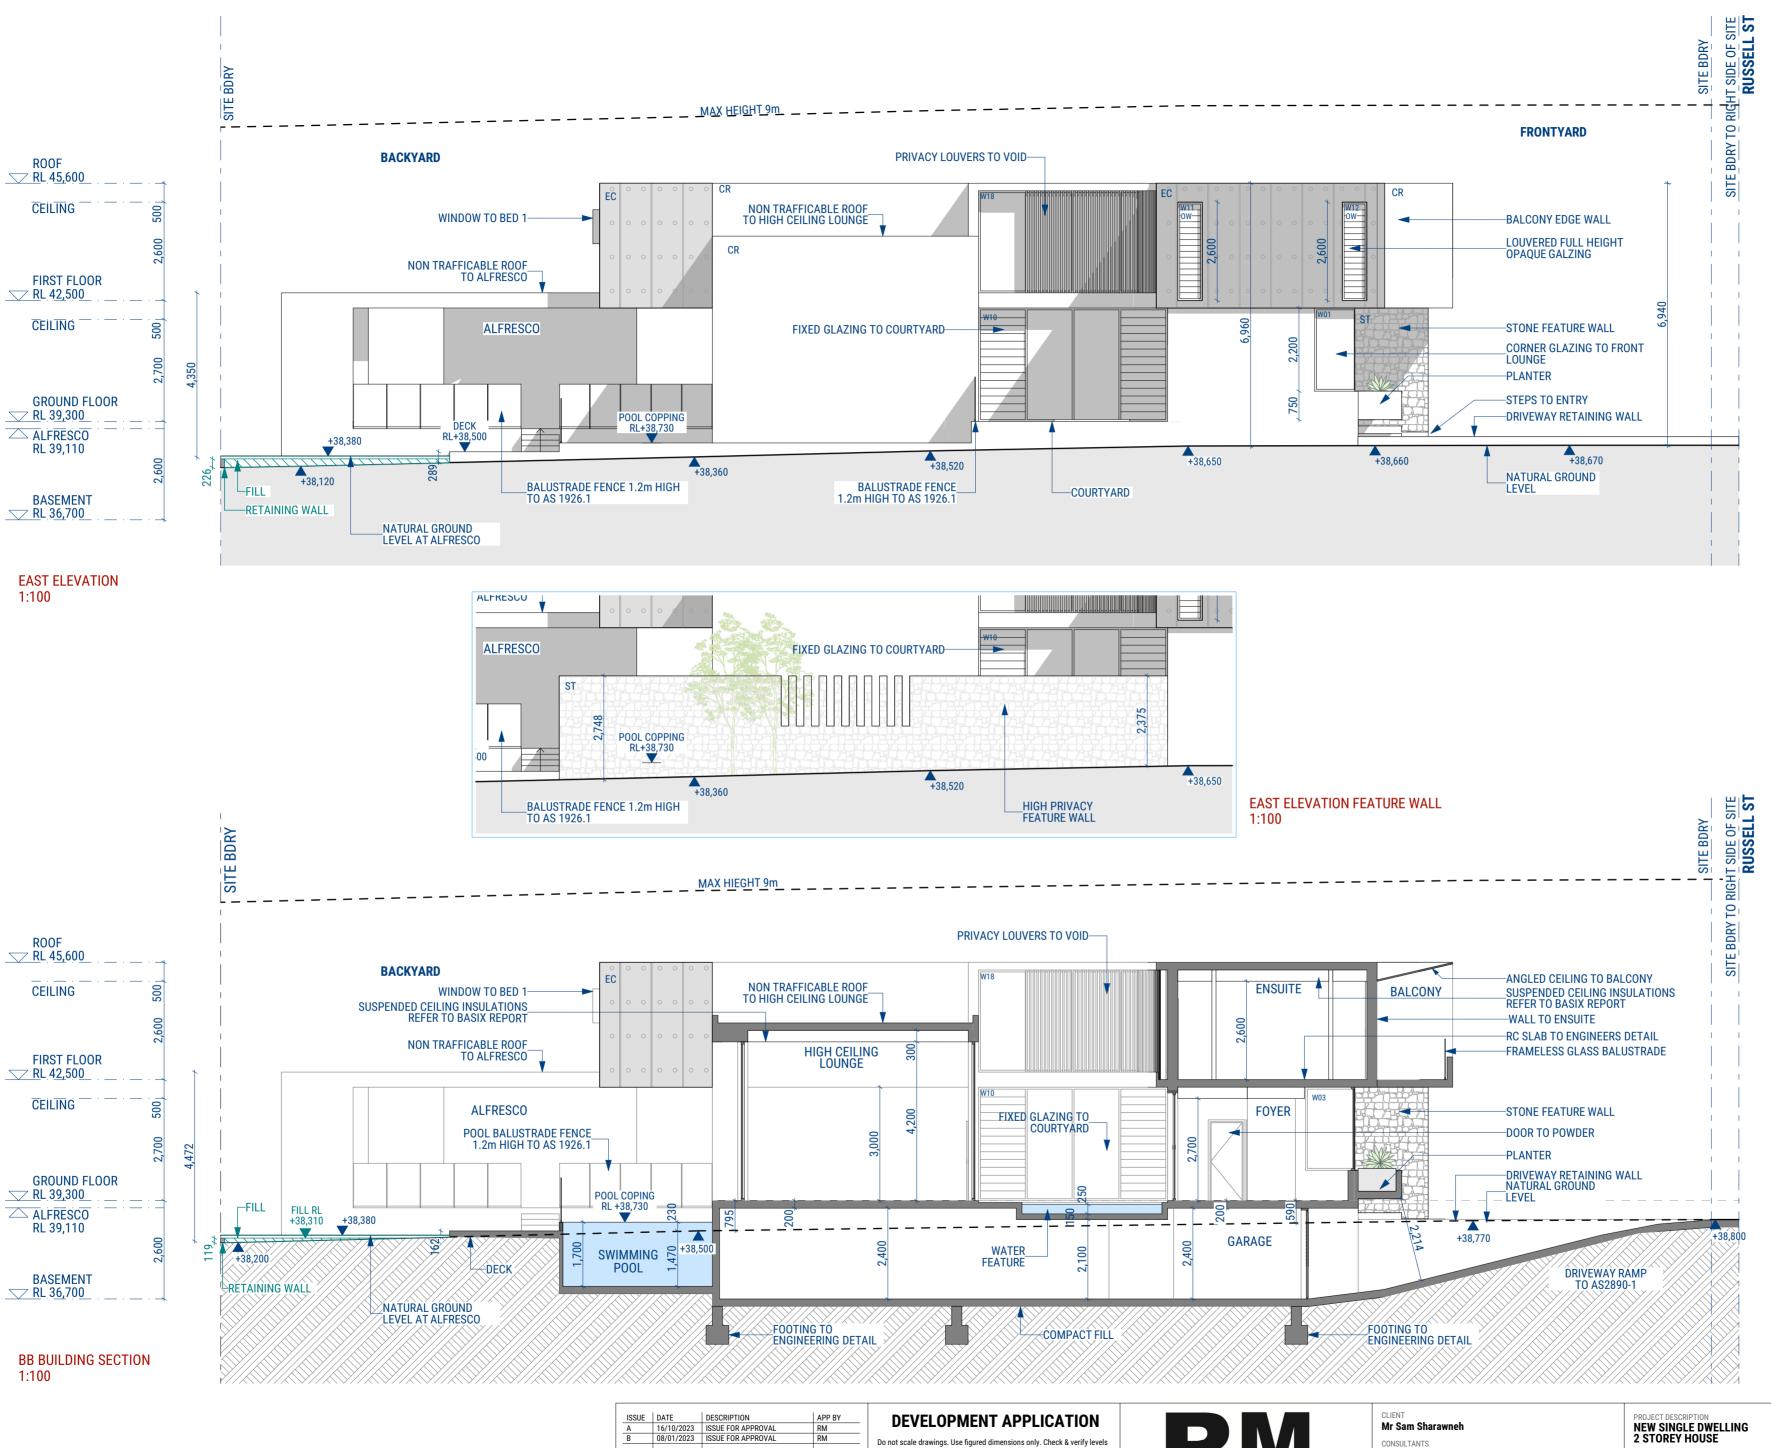PROJECT DESCRIPTION
NEW SINGLE DWELLING
2 STOREY HOUSE

PROJECT NUMBER
23002

DRAWING TITLE
EAST ELEVATION + BB SECTION

DRAWING NUMBER SCALE ISSUE
DA 31


DRAWING STATUS
NOT FOR CONSTRUCTION


A2

LEGEND

CR - CEMENT RENDER OW - OPAQUE WINDOW

EC - EXPOSED CONCRETE ST - STONE WALL MC - METAL CLADDING

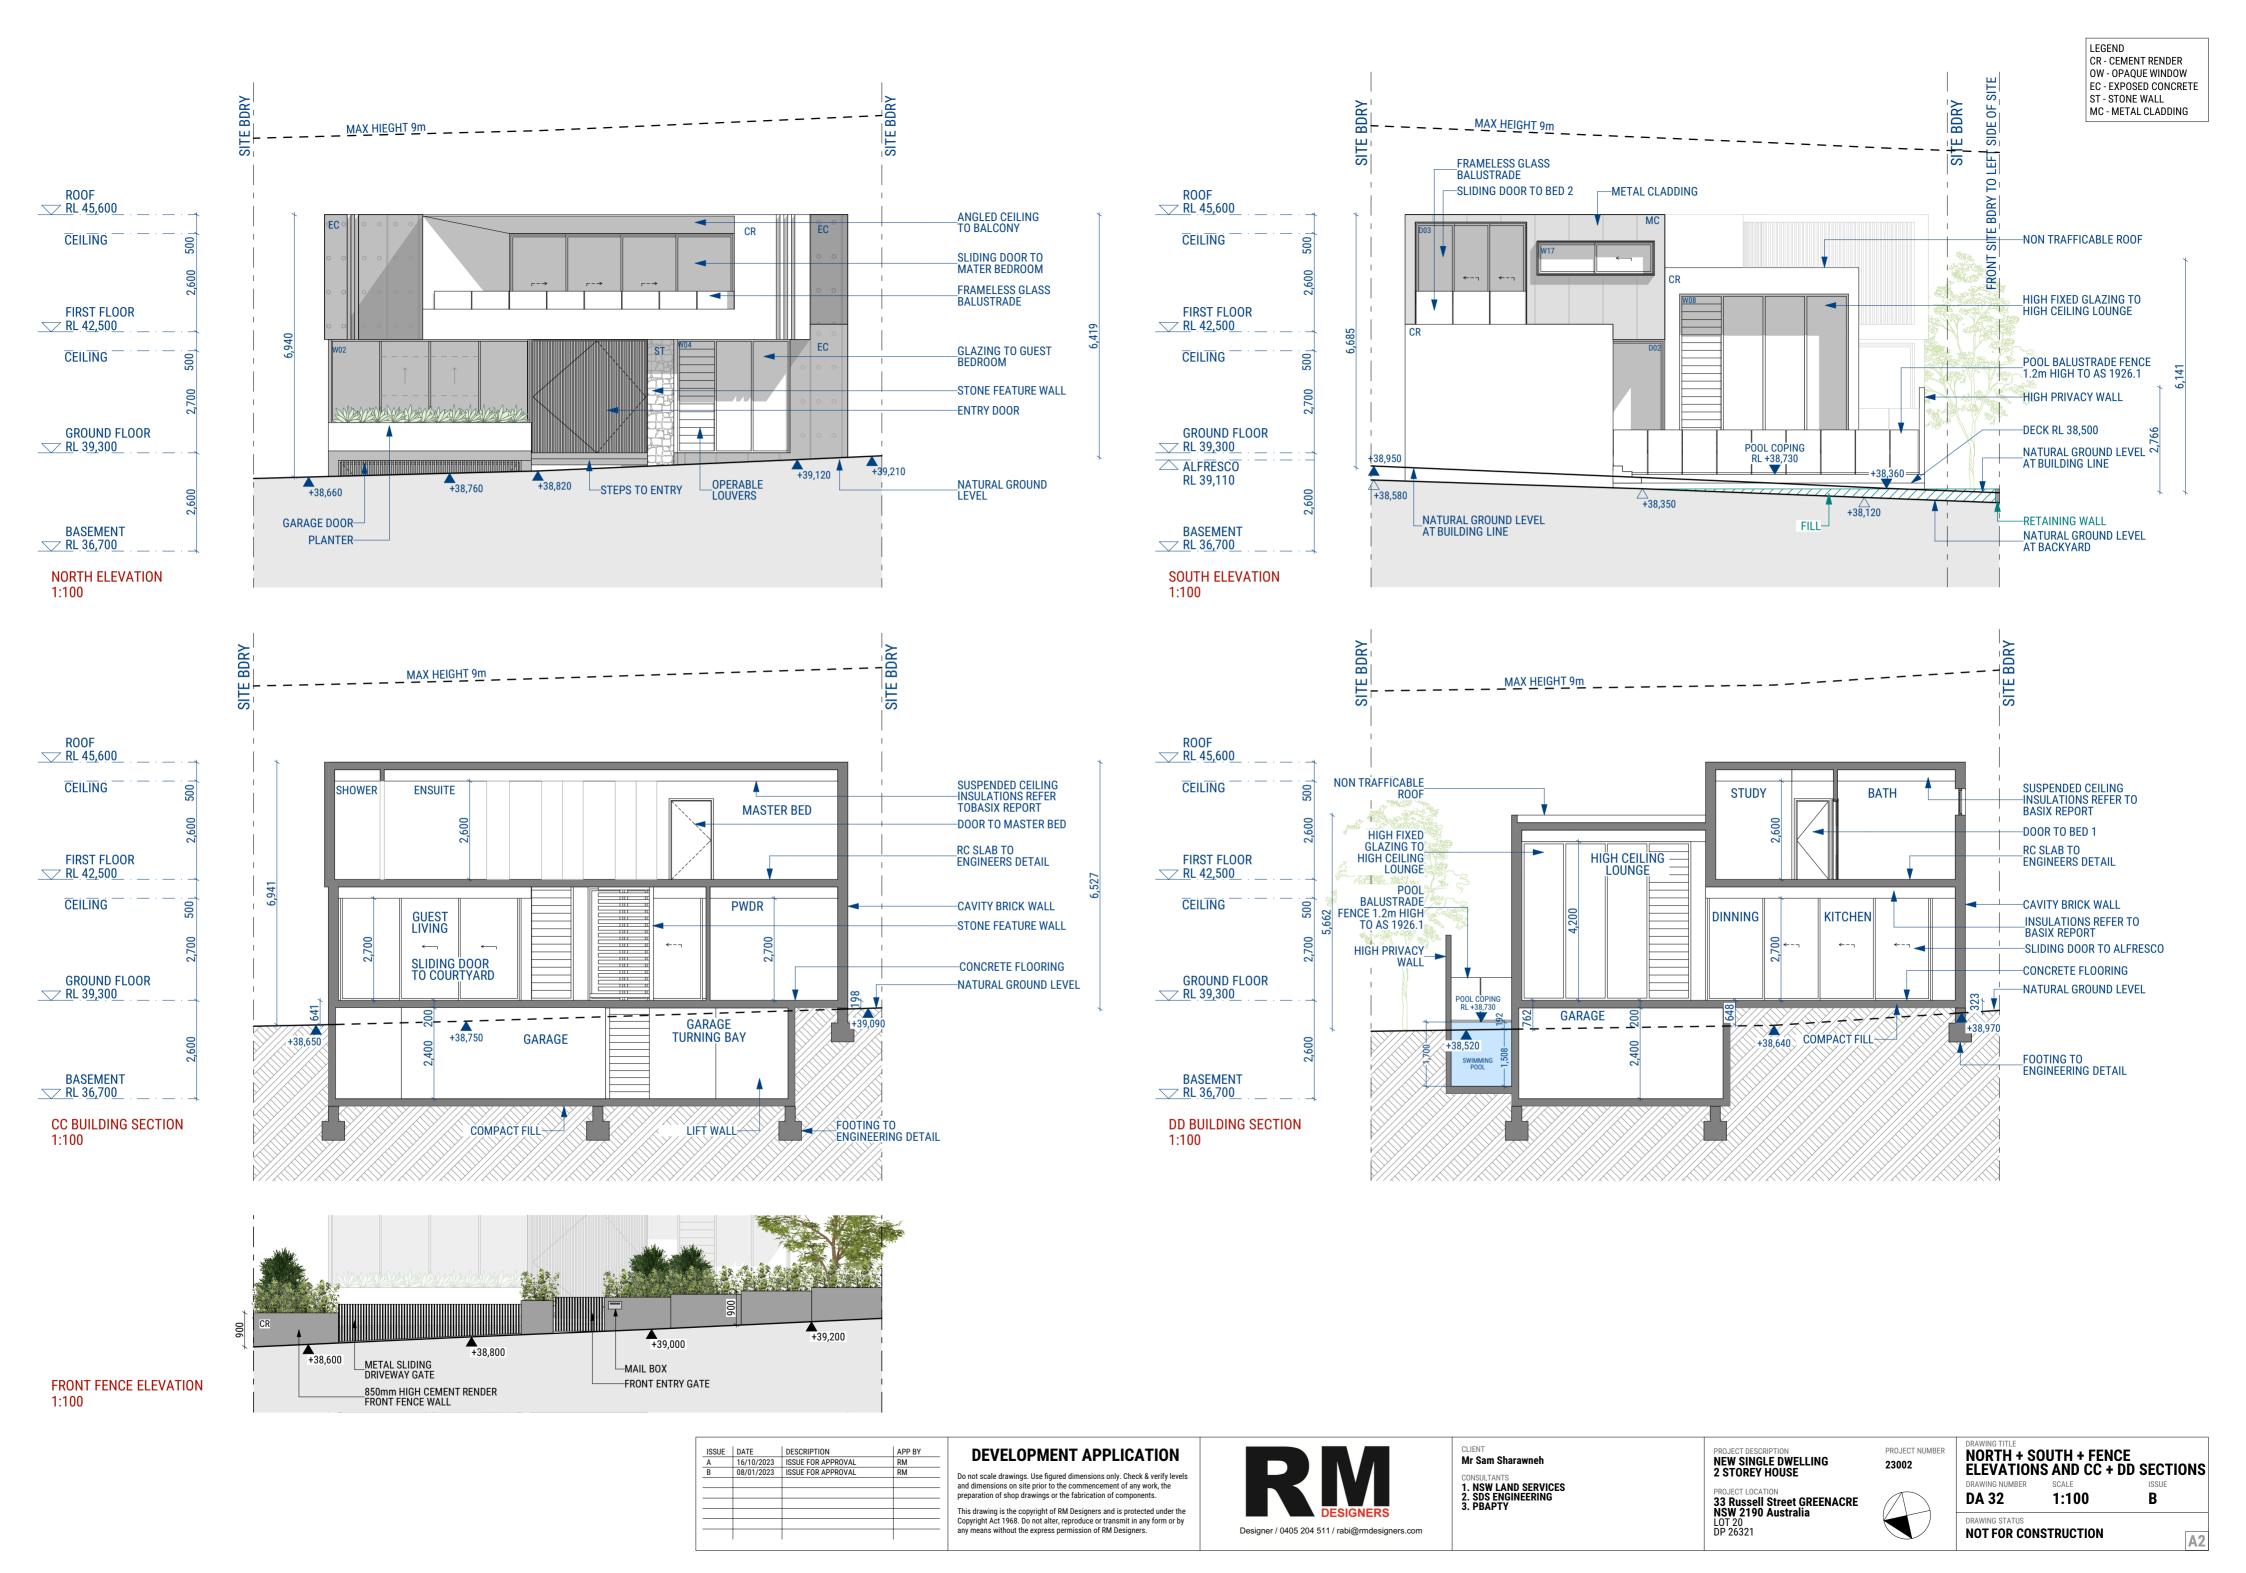

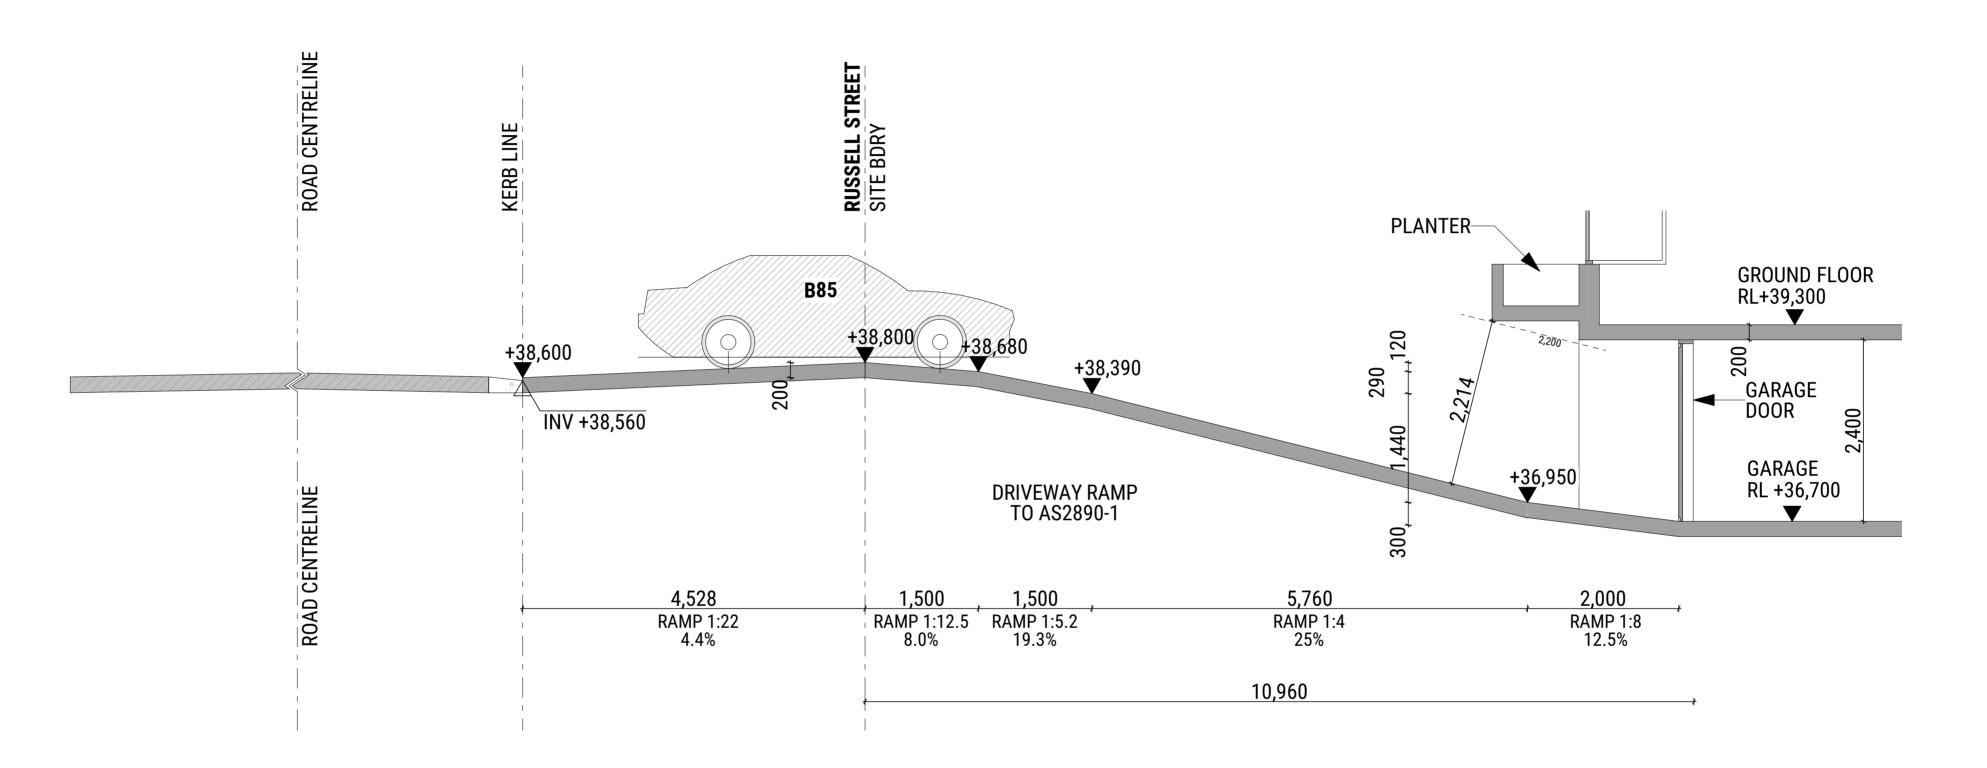

FF RAMP SECTION 1:50


ISSUE	DATE	DESCRIPTION	APP BY	DEVELOPMENT APPLICATION
Α	16/10/2023	ISSUE FOR APPROVAL	RM	DEVELOR WILLIAM AFFEIGATION
В	08/01/2023	ISSUE FOR APPROVAL	RM	Do not scale drawings. Use figured dimensions only. Check & verify levels
				and dimensions on site prior to the commencement of any work, the
				preparation of shop drawings or the fabrication of components.
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				This drawing is the copyright of RM Designers and is protected under the
				Copyright Act 1968. Do not alter, reproduce or transmit in any form or by any means without the express permission of RM Designers.
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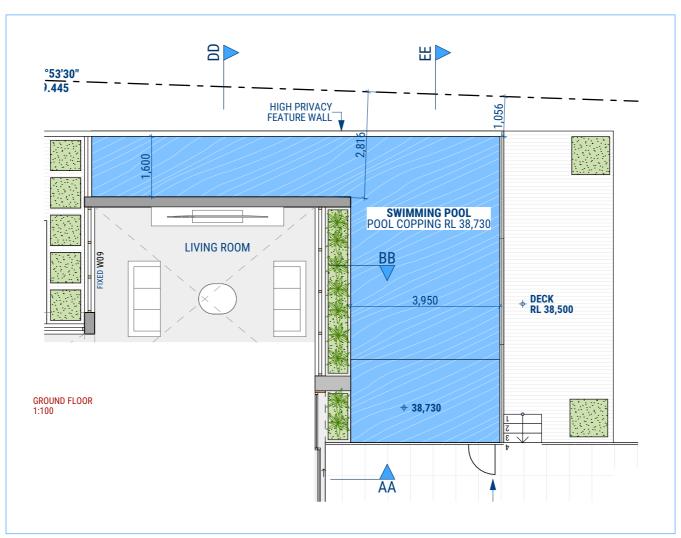






PROJECT DESCRIPTION NEW SINGLE DWELLING 2 STOREY HOUSE	PROJECT NUMBER 23002	FF RAMP S	ECTION
PROJECT LOCATION		DRAWING NUMBER	SCALE
33 Russell Street GREENACRE NSW 2190 Australia		DA 33	1:50
LOT 20 DP 26321		NOT FOR CON	STRUCTIO

ISSUE



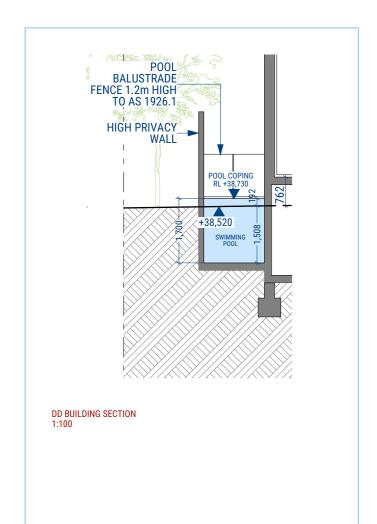

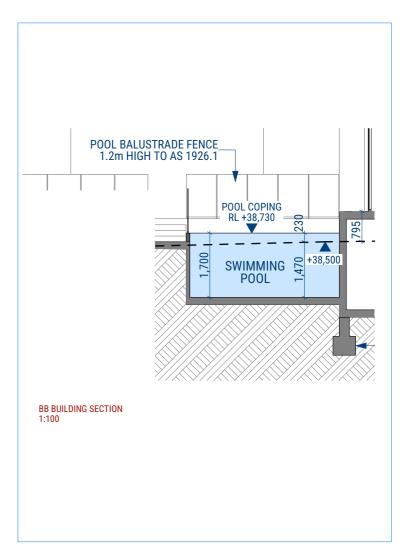

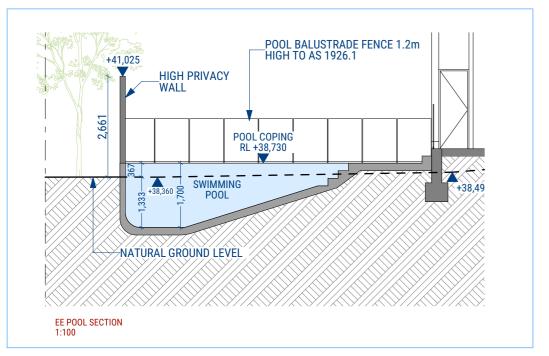

### SWIMMING POOL REQUIREMENTS

- ALL POOLS MUST BE SEPARATED FROM RESIDENTIAL BUILDINGS AND ADJOINING PUBLIC OR PRIVATE PROPERTIES BY A COMPLYING CHILD -RESISTANT BARRIER (MUST BE IN ACCORDANCE WITH THE REGULATIONS AND AS 1926.1-2012 SWIMMING POOL SAFETY).
- · NO DOOR ACCESS FROM A RESIDENTIAL BUILDING INTO AN OUTDOOR POOL IS PERMITTED
- ONLYSTRUCTURES ASSOCIATED WITH THE POOL (FILTERHOUSING, ETC.) ARE PERMITTED WITHIN THE ENCLOSED POOL AREA
- STRUCTURES SUCH AS CLOTHES LINES , BARBEQUE, SHEDS, ENTERTAINMENT STRUCTURE, OUTSIDE TOILETS, ETC, MUST ALL BE LOCATED OUTSIDE THE CHILD RESISTANT BARRIER
- POOL FENCING SWIMMING POOL FENCING AND OTHER BARRIERS TO BE PROVIDED TO THE POOL AREA IN ACCORDANCE WITH THE SWIMMING POOLS ACT 1992.
- BOUNDARY FENCE TO BE 1.8m IN HEIGHT, MEASURED FROM INSIDE OF THE FENCING - SWIMMING POOL FENCING TO BE AT LEAST  $\,$  1.2m High , Measured on the outside
- MINIMUM 900mm SEPARATION BETWEEN THE UPPER AND LOWER HORIZONTAL MEMBERS TO MAINTAIN NON -CLIMBABLE ZONE
- · HORIZONTAL MEMBERS OF THE FENCE SHOULD BE PLACED ON THE INSIDE OF THE FENCE AND BE AT LEAST 900mm APART.
- THE LATCHING DEVICE TO THE POOL GATE IS TO BE LOCATED A MINIMUM 1.5m ABOVE GROUND LEVEL AND 1.4m FROM THE HIGHEST LOWER HORIZONTAL BARRIER MEMBER OR , ALTERNATIVELY , THE DEVICE IS TO BE LOCATED INSIDE THE GATE AND THE LATCHING DEVICE IS TO BE APPROPRIATELY SHIELDED FROM THE OUTSIDE IN ACCORDANCE WITH AS 1926.1-2012 (EXCLUDING CLAUSE 2.8 OF THE STANDARD ) TO ENSURE THE LATCHING DEVICE IS ONLY ACCESSIBLE BY
- REACHING OVER THE GATE .

  GATE WIDTH IS TO BE KEPT TO A MINIMUM (NO MORE THAN 1 METRE) TO MINIMISE THE POSSIBILITY OF THE WEIGHT OF THE GATE CAUSING THE GATE TO DROP WITH THE SELF -LATCHING MECHANISM FAILING.
- SPA POOLS ARE ALSO COVERED BY THE LEGISLATION AND SHOULD BE SEPARATED BY A CHILD -RESISTANT POOL SAFETY BARRIER IN ACCORDANCE

- WITH AUSTRALIAN STANDARD AS 1926.1-2012.
- · ALTERNATIVELY . THE SPA POOL MUST BE COVERED AND SECURED BY A LOCKABLE CHILD -SAFE STRUCTURE (SUCH AS A DOOR, LID, GRILLE OR MESH). SUCH LOCKABLE STRUCTURE MUST BE ABLE TO BE REMOVED /INSTALLED AND LOCKED BY A SINGLE PERSON RESUSCITATION WARNING SIGN
- AN APPROPRIATE RESUSCITATION WARNING SIGN (AVAILABLE FROM COUNCIL) OR THE ROYAL LIFE SAVING SOCIETY  $\;$  ) IS DISPLAYED IN A PROMINANT POSITION IN THE IMMEDIATE VICINITY OF THE POOL AREA  $\;$  .
- THE SPACING OF VERTICAL MEMBERS OF THE FENCE SHALL NOT EXCEED
- 100 mm.

  THE HEIGHT OF ANY OPENING BETWEEN THE BOTTOM OF THE FENCE AND FINISHED GROUND LEVEL SHALL NOT EXCEED 100 mm
- ALL SWIMMING POOL FENCING TO BE MAINTAINED IN A GOOD CONDITION WITH NO HOLES . BROKEN OR LOOSE PALINGS ).
- NON-CLIMBABLE ZONE EXTENDS FROM THE POOL FENCE 300mm INTO THE POOL AREA AND 900mm OUTSIDE THE POOL AREA . TO PREVENT A CHILD TO CLIMB OVER THE FENCE , CLIMBABLE OBJECTS SUCH AS BARBEQUES , FURNITURE , PLANTER BOXES . TREES OR SHRUB ARE NOT PERMITTED WITHIN THIS NON CLIMBABLE ZONE
- IF THE WALL OF THE HOUSE FORMS PART OF THE APPROVED CHILD -RESISTANT BARRIER TO THE POOL AREA (ie. IN RELATION TO POOLS INSTALLED BEFORE 1 AUGUST 1990), ALL DOOR AND WINDOW OPENINGS IN THE WALL /S MUST BE CHILD-RESISTANT IN ACCORDANCE WITH THE REGULATIONS TO PREVENT CHILDREN ACCESSING THE POOL AREA
- . POOL GATES
- GATES TO THE SWIMMING POOL AREA ARE TO OPEN OUTWARDS AND ARE TO BE FULLY SELF -CLOSING AND SELF -LATCHING FROM ANY OPEN POSITION.
- NO DOUBLE GATES ARE PERMITTED
   GATES ARE NOT TO BE PROPPED OPEN AT ANY TIME
- THE FOLLOWING WARNING STATEMENTS MUST BE CONTAINED WITHIN THE RESUSCITATION SIGN :
- YOUNG CHILDREN SHOULD BE SUPERVISED WHEN USING
- THIS SWIMMING POOL
- POOL GATES MUST BE KEPT CLOSED AT ALL TIMES
   KEEP ARTICLES , OBJECTS AND STRUCTURES AT LEAST 900
- MM CLEAR OF THE POOL FENCE AT ALL TIMES

• THE RESUSCITATION SIGN MUST BE

COMPLETE LIST OF REQUIREMENTS

• LEGIBLE FROM A DISTANCE OF AT LEAST THREE METRES · MAINTAINED IN A CLEARLY LEGIBLE CONDITION REFER TO THE SWIMMING POOLS ACT 1992 THE SWIMMING POOLS REGULATION 2018 AND AUSTRALIAN STANDARD AS 1926.1-2012 (EXCLUDING CLAUSE 2 8 OF THE STANDARD ) FOR A

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	ISSUE	DATE	DESCRIPTION	APP BY
	A	16/10/2023	ISSUE FOR APPROVAL	RM
	В	08/01/2023	ISSUE FOR APPROVAL	RM

### **DEVELOPMENT APPLICATION**

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# Mr Sam Sharawneh

1. NSW LAND SERVICES
2. SDS ENGINEERING
3. PBAPTY

### **NEW SINGLE DWELLING 2 STOREY HOUSE**

**33 Russell Street GREENACRE** NSW 2190 Australia

23002

PROJECT NUMBER

**POOL PLAN AND SECTIONS** 


DRAWING NUMBER DA 34

DRAWING STATUS **NOT FOR CONSTRUCTION** 

ISSUE

В



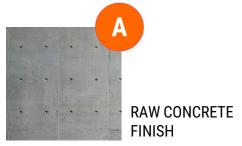

CEMENT RENDER
DULUX
NATURAL WHITE





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4	16/10/2023	ISSUE FOR APPROVAL	RM

## **DEVELOPMENT APPLICATION**

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PROJECT DESCRIPTION  NEW SINGLE DWELLING
2 STOREY HOUSE

PROJECT LOCATION
33 Russell Street GREENACRE
NSW 2190 Australia
LOT 20
DP 26321

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PROJECT	NUMBE

FINISHES SCHEDULE


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DRAWING STATUS

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ISSUE





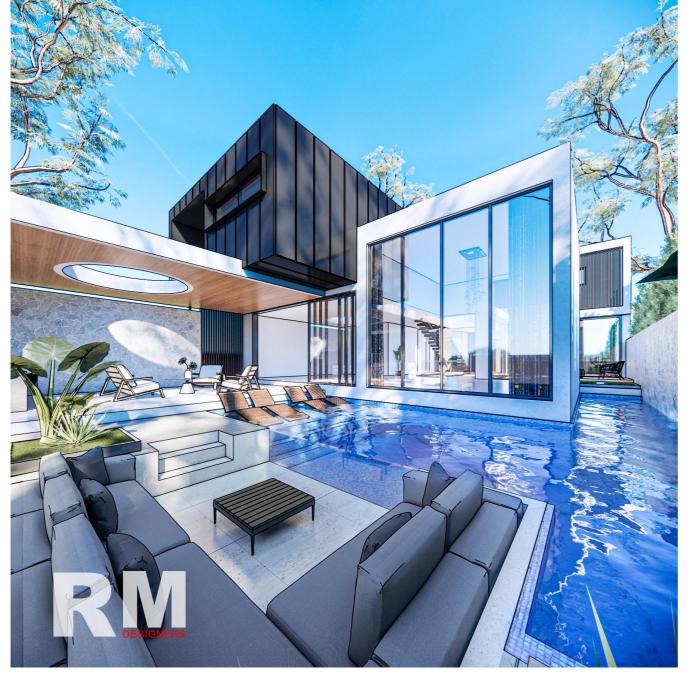

ISSUE	DATE	DESCRIPTION	APP BY
Α	16/10/2023	ISSUE FOR APPROVAL	RM

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CLIENT
Mr Sam Sharawneh

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PROJECT DESCRIPTION
NEW SINGLE DWELLING
2 STOREY HOUSE

PROJECT LOCATION
33 Russell Street GREENACRE
NSW 2190 Australia
LOT 20
DP 26321


23002


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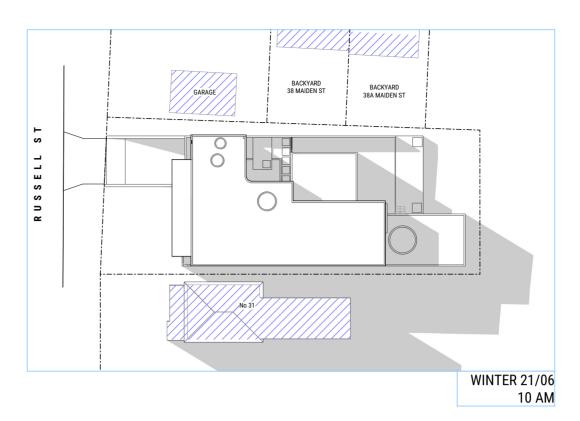
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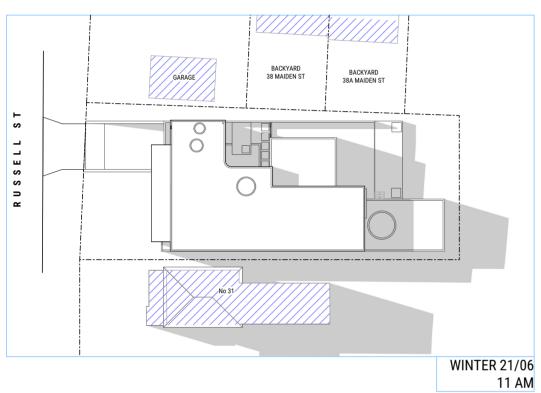
DRAWING STATUS **NOT FOR CONSTRUCTION** 


ISSUE







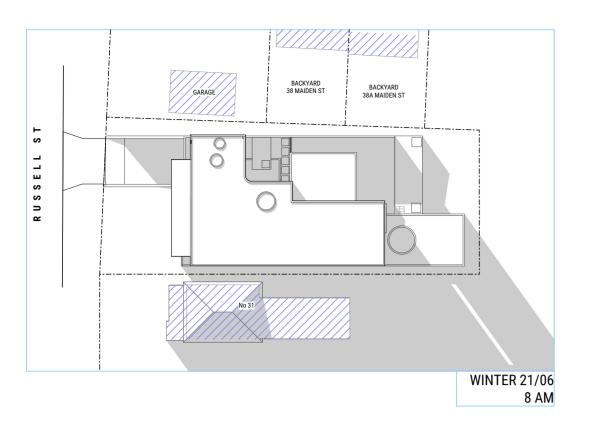


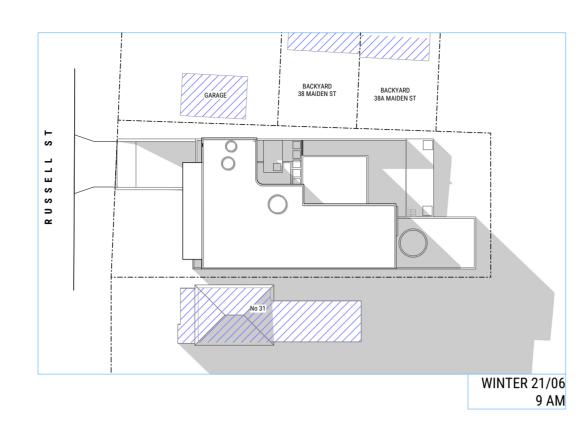


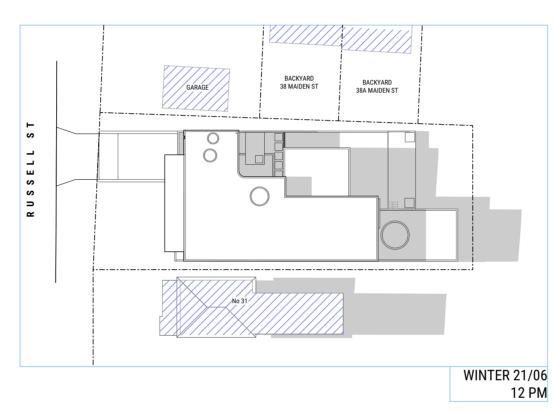

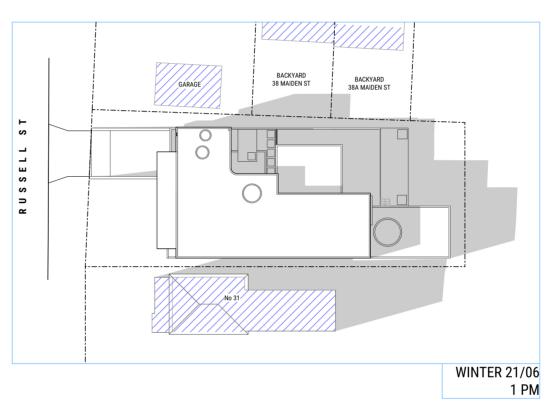

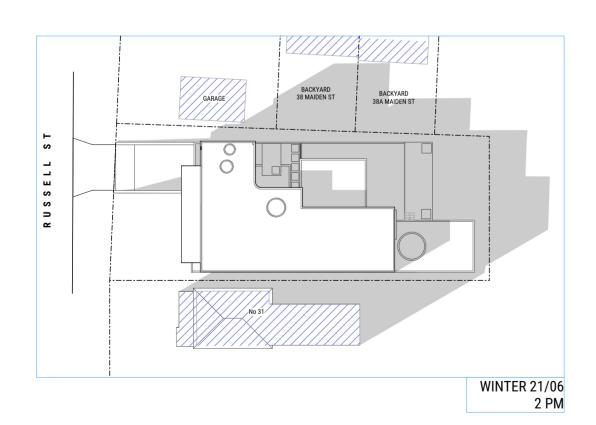

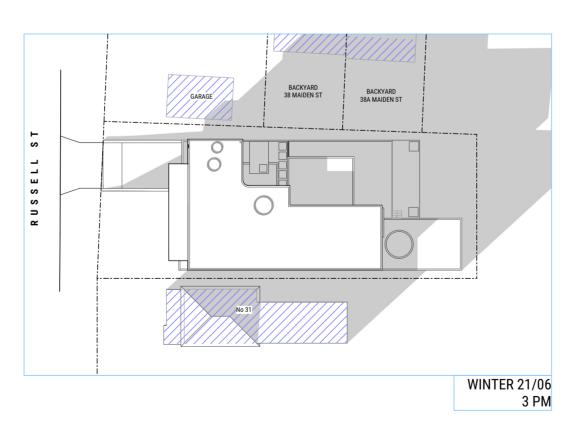

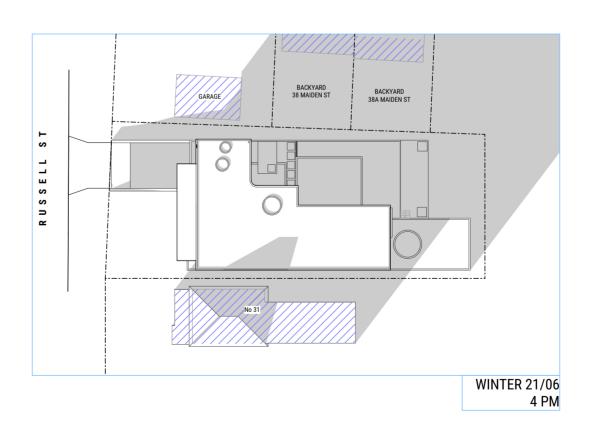

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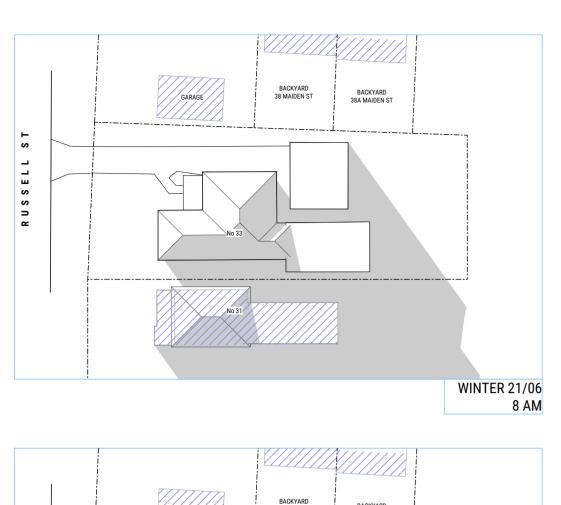
CLIENT
Mr Sam Sharawneh
CONSULTANTS
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2. SDS ENGINEERING
3. PBAPTY


PROJECT DESCRIPTION
NEW SINGLE DWELLING
2 STOREY HOUSE
PROJECT LOCATION
33 Russell Street GREENACRE
NSW 2190 Australia
LOT 20
DP 26321


PROJECT NUMBER 23002


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SHADOW DIAGRAMS WINTER PROPOSED
DRAWING NUMBER SCALE ISSUE
DA 50 1:400 B


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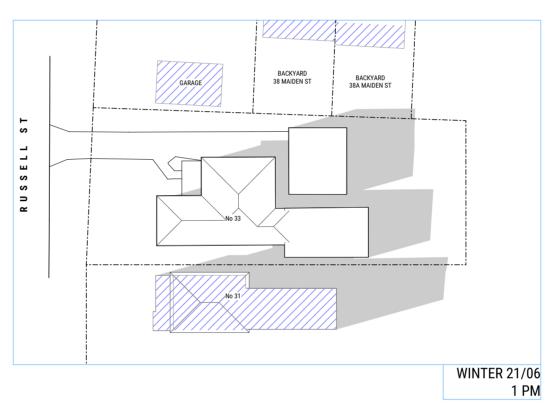





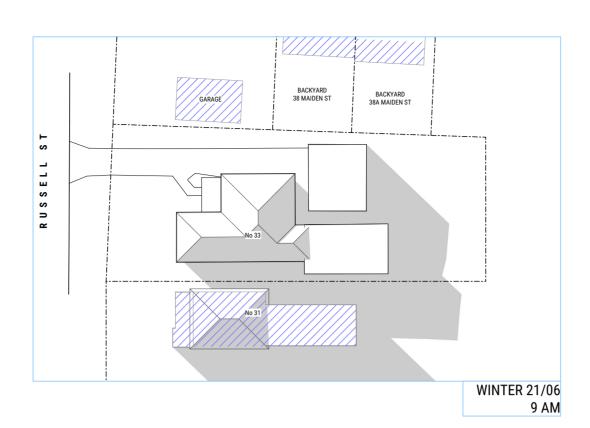


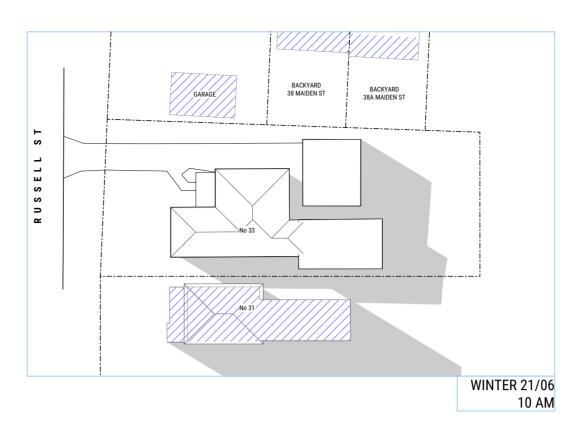


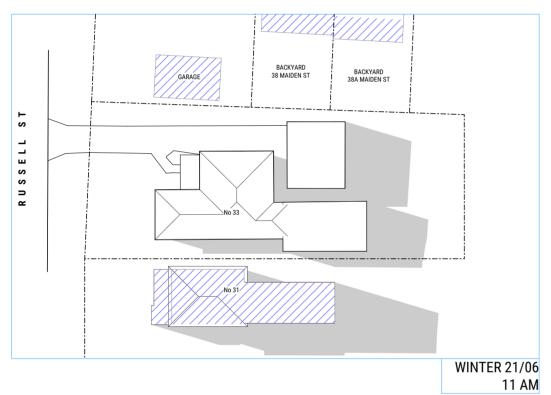

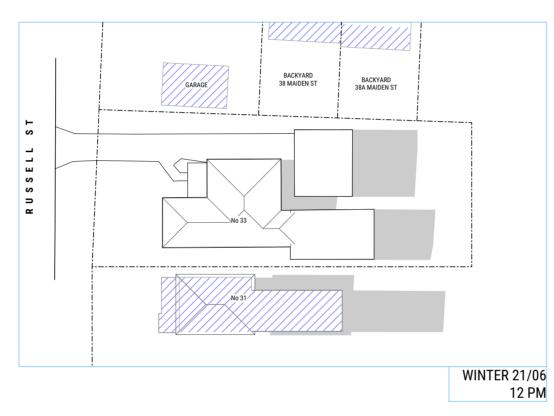

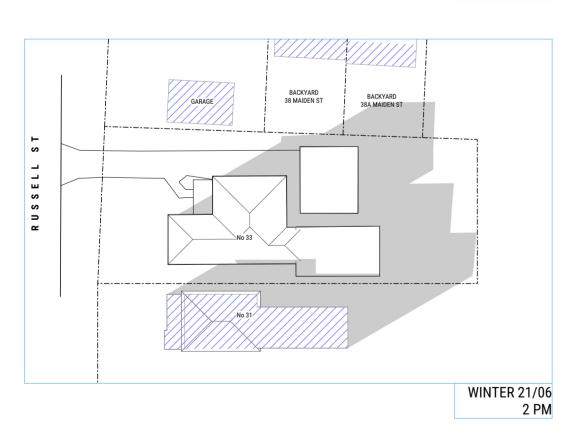

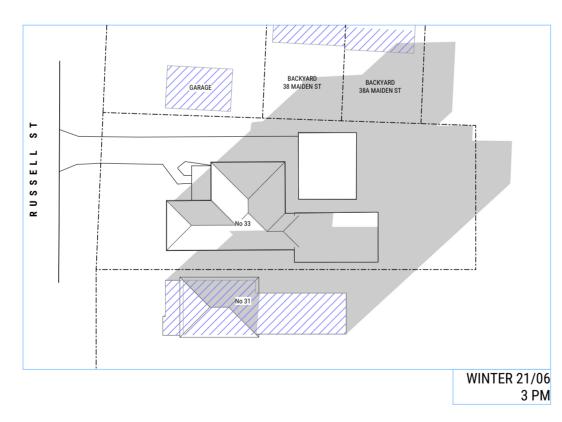

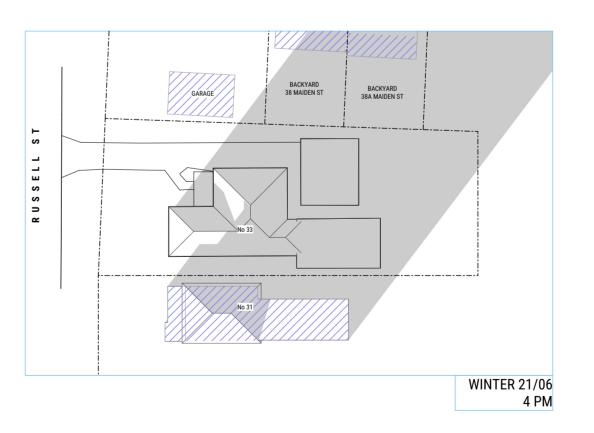

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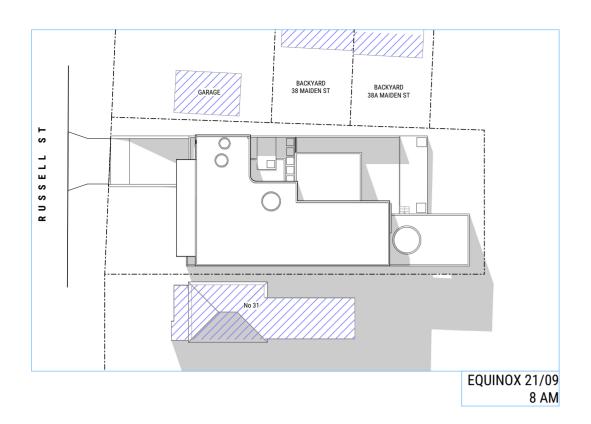
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NEW SINGLE DWELLING
2 STOREY HOUSE
PROJECT LOCATION
33 Russell Street GREENACRE
NSW 2190 Australia
LOT 20
DP 26321


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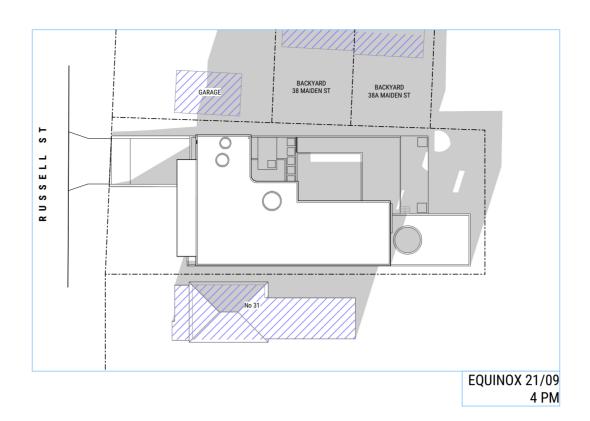
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DA 51 1:400 A


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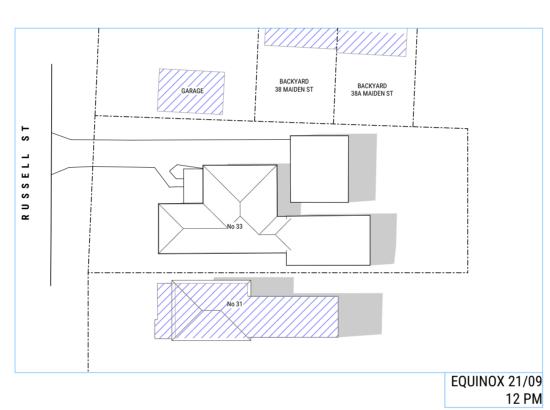
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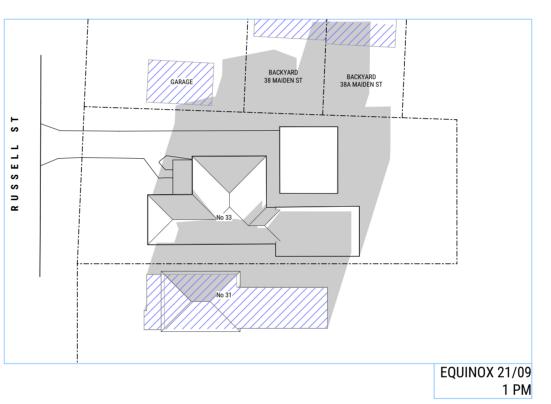








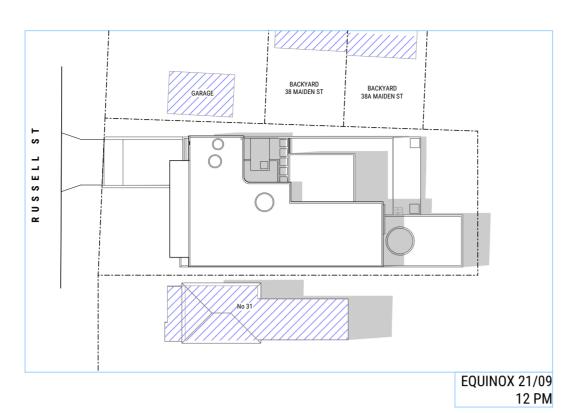

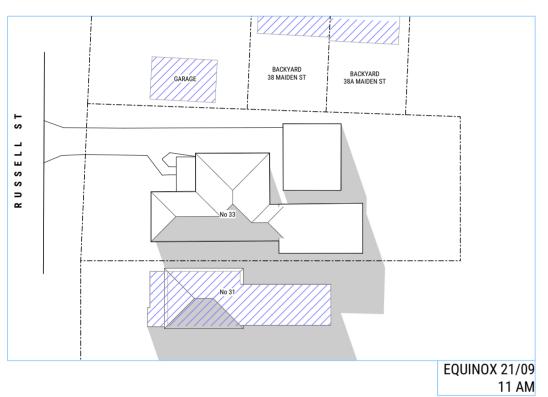

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Α	16/10/2023	ISSUE FOR APPROVAL	RM
В	08/01/2023	ISSUE FOR APPROVAL	RM



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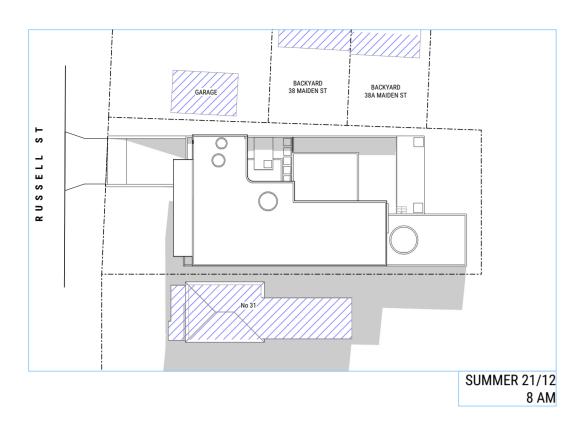



PROJECT DESCRIPTION
NEW SINGLE DWELLING
2 STOREY HOUSE
PROJECT LOCATION
33 Russell Street GREENACRE
NSW 2190 Australia
LOT 20
DP 26321


PROJECT NUMBER
23002


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SHADOW DIAGRAMS EQUINOX
DRAWING NUMBER SCALE ISSUE
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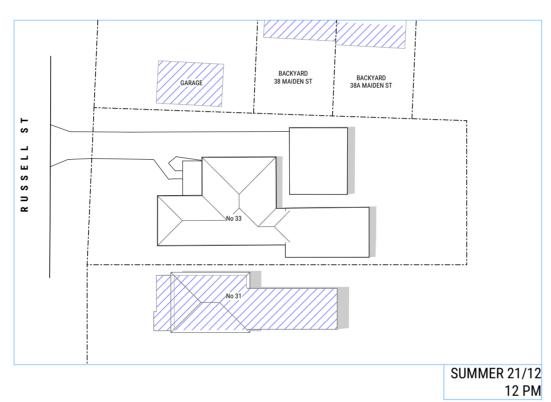
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NOT FOR CONSTRUCTION






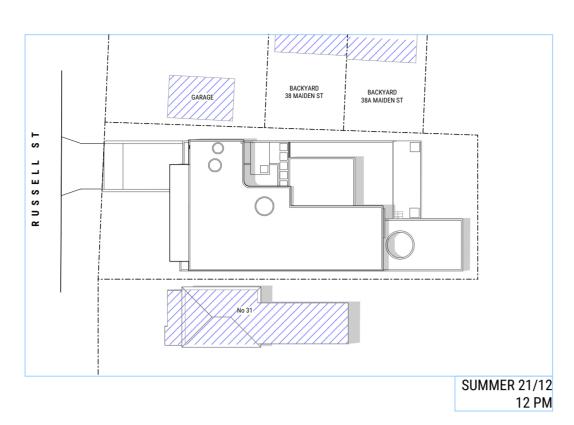

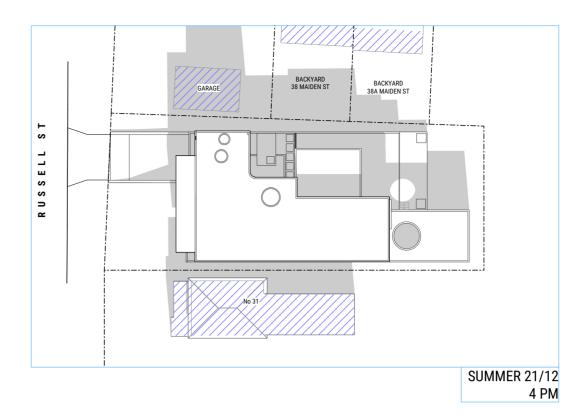

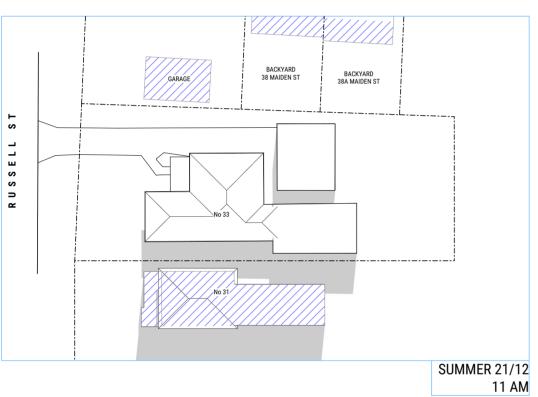

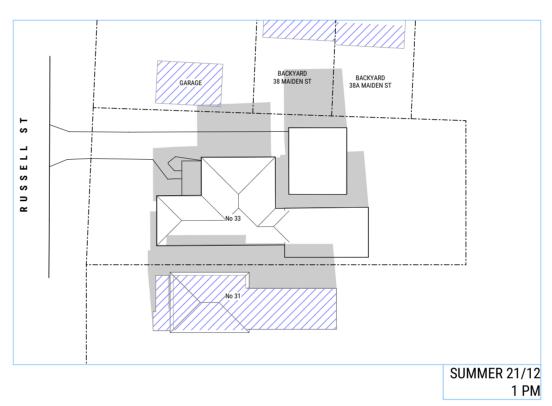

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CONSULTANTS  1. NSW LAND SERVICES 2. SDS ENGINEERING 3. PBAPTY

PROJECT DESCRIPTION
NEW SINGLE DWELLING
2 STOREY HOUSE

PROJECT NUMBER 23002

DRAWING TITLE
SHADOW DIAGRAMS SUMMER
DRAWING NUMBER SCALE ISSUE
DA 53 1:400 B

PROJECT LOCATION

33 Russell Street GREENACRE
NSW 2190 Australia
LOT 20
DP 26321

DRAWING NUMBER SCALE

DA 53 1:400

DRAWING STATUS

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						Window Schedule						
Element ID	D01	D02	D03	D04	W01	W02	W03	W04	W05	W06	W07	W08
Home Story Name	GROUND FLOOR	GROUND FLOOR	FIRST FLOOR	FIRST FLOOR	GROUND FLOOR	GROUND FLOOR	GROUND FLOOR	GROUND FLOOR	GROUND FLOOR	GROUND FLOOR	GROUND FLOOR	GROUND FLOOR
W x H Size	4,830×2,900	6,000×3,000	2,950×2,900	5,950×2,600	970×2,200	5,010×2,200	1,210×2,200	2,970×3,000	900×700	650×2,700	2,220×700	4,470×4,200
Sill height	0	0	0	0	800	800	800	0	1,700	0	900	0
Head height	2,900	3,000	2,900	2,600	3,000	3,000	3,000	3,000	2,400	2,700	1,600	4,200
GlassType	Glass - Clear Fast	Glass - Clear	Glass - Clear	Glass - Clear	Glass - Clear	Glass - Opaque	Glass - Opaque	Glass - Clear	Glass - Clear			
Frame						OPERABLE		OPERABLE				OPERABLE
View from Reveal Side						1 1						
					Window Schedule							
Element ID	W09	W10	W11	W12	W13	W14	W15	W16	W17	W18		
Home Story Name	GROUND FLOOR	GROUND FLOOR	FIRST FLOOR	FIRST FLOOR	FIRST FLOOR	FIRST FLOOR	FIRST FLOOR	FIRST FLOOR	FIRST FLOOR	FIRST FLOOR		
W x H Size	2,790×4,200	5,000×3,000	650×2,600	650×2,600	900×900	2,200×900	2,100×700	2,200×900	3,110×900	5,000×2,700		
Sill height	0	0	0	0	1,500	1,500	1,700		1,500	200		
Head height	4,200	3,000	2,600	2,600	2,400	2,400	2,400	,	2,400	2,900		
GlassType	Glass - Clear	Glass - Clear	Glass - Opaque	Glass - Opaque	Glass - Clear	Glass - Clear	Glass - Opaque	Glass - Clear	Glass - Clear	Glass - Clear		
Frame	OPERABLE	OPERABLE										
View from Reveal Side						<b>□</b>		<b>┌→</b>	←,			

ISSUE	DATE	DESCRIPTION	APP BY
Α	16/10/2023	ISSUE FOR APPROVAL	RM
В	08/01/2023	ISSUE FOR APPROVAL	RM

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Mr Sam Sharawneh

CONSULTANTS
1. NSW LAND SERVICES
2. SDS ENGINEERING
3. PBAPTY

PROJECT DESCRIPTION
NEW SINGLE DWELLING
2 STOREY HOUSE

PROJECT LOCATION
33 Russell Street GREENACRE
NSW 2190 Australia
LOT 20
DP 26321

PROJECT NUMBER

23002


DRAWING NUMBER

WINDOWS AND DOORS SCHEDULE


**DA 60** 


ISSUE В


DRAWING STATUS **NOT FOR CONSTRUCTION** 

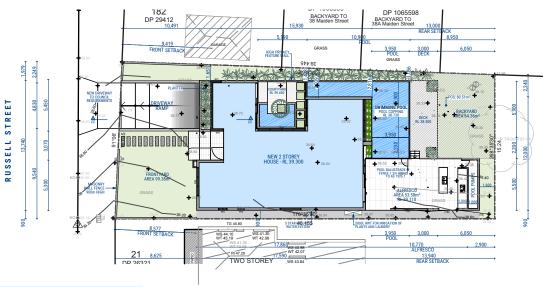


SITE PLAN 1:400

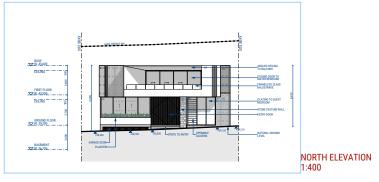

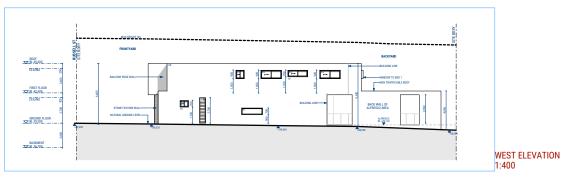

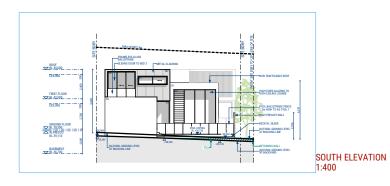

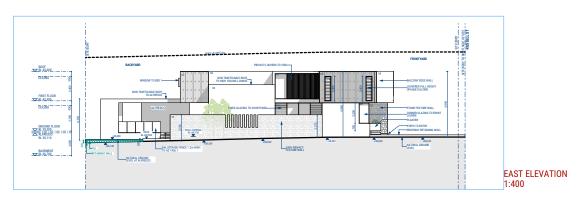

ISSUE	DATE	DESCRIPTION	APP BY
A	16/10/2023	ISSUE FOR APPROVAL	RM
В	08/01/2023	ISSUE FOR APPROVAL	RM

### **DEVELOPMENT APPLICATION**


R
Designer / 0405 204 511 / rabi@rmdesigners.com

Client
Mr Sam Sharawneh
Consultants
1. NSW LAND SERVICES
2. SDS ENGINEERING
3. PRAPTY

Project Description	Proiec
NEW SINGLE DWELLING 2 STOREY HOUSE	23002
Project Location 33 Russell Street	(
GREENACRE NSW 2190	<u></u>

	Drawing Status	
1		1:400
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ect Number	Drawing Title	

Drawing Status	ОМЕТВИСТИ		
DA 70	1:400	В	
Drawing Number	Scale	Issue	
NOTIFICAT	ION		A4
Drawing Title			A 4

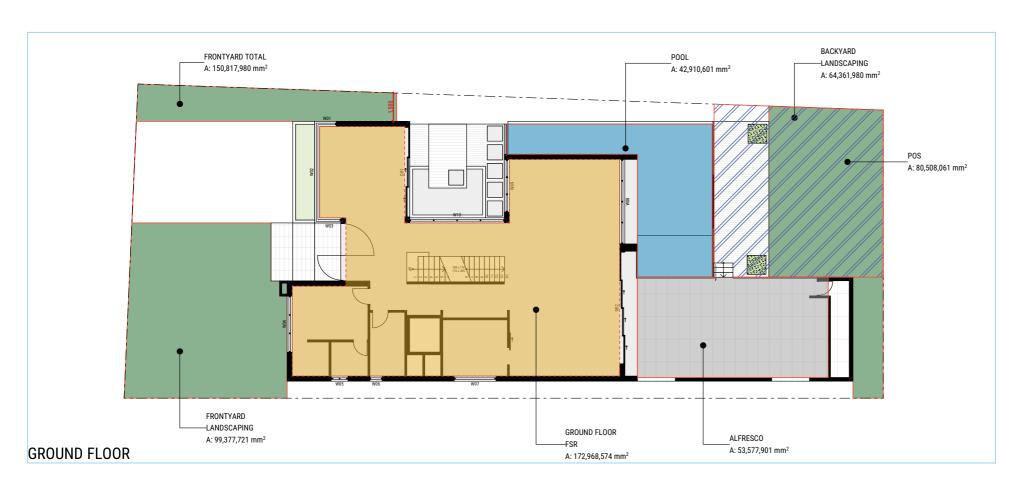



	Total Areas	
Zone Number	Zone Name	Measured Area
	ALFRESCO	53.58
	BED 2 BALC	4.43
	FRONTYARD TOTAL	150.82
	MASTER BED BALC	12.19
	POOL	42.91
	POS	80.51
	VOID	16.10
		360.54 m <sup>2</sup>
FSR	FISRT FLOOR	143.16
FSR	GROUND FLOOR	172.97
		316.13 m <sup>2</sup>
LANDSCAPING	BACKYARD	64.36
LANDSCAPING	FRONTYARD	99.38
		163.74 m <sup>2</sup>

DATE	DESCRIPTION	APP BY
16/10/2023	ISSUE FOR APPROVAL	RM
08/01/2023	ISSUE FOR APPROVAL	RM
	16/10/2023	16/10/2023 ISSUE FOR APPROVAL

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### Mr Sam Sharawneh

1. NSW LAND SERVICES
2. SDS ENGINEERING
3. PBAPTY

# PROJECT DESCRIPTION NEW SINGLE DWELLING 2 STOREY HOUSE

PROJECT LOCATION
33 Russell Street GREENACRE
NSW 2190 Australia
LOT 20
DP 26321

PROJECT NUMBER 23002

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DRAWING TITLE			
ARFA CAI	CIII	ΔΤΙ	ONS

SCALE DRAWING NUMBER ISSUE В 1:200

DRAWING STATUS **NOT FOR CONSTRUCTION**